

together with all Authorities' requirements and Regulations.

REV DATE DESCRIPTION
A 18.05.2022 ISSUE FOR DESIGN COORDINATION B 03.06.2022 ISSUE FOR DESIGN COORDINATION 06.06.2022 ISSUE FOR PRELIMINARY QS D 08.06.2022 ISSUE FOR DA DESIGN COORDINATION E 15.06.2022 ISSUE FOR DA DESIGN COORDINATION 24.06.2022 ISSUE FOR DA DESIGN COORDINATION G 28.06.2022 ISSUE FOR DA SUBMISSION H 12.09.2022 ISSUE FOR DA RFI SUBMISSION

WALL LEGEND

CONCRETE WORK EXISTING ELEMENT DEMOLISHED ELEMENT

BRICKWORK BLOCKWORK

**DEMOLITION NOTES** VERIFY ALL EXISTING CONDITIONS ON SITE PRIOR TO

COMMENCING. NOTIFY ARCHITECT IF SITE CONDITIONS VARY FROM DRAWINGS.

REQUIREMENT / WORKS. WHERE THE CONTRACTOR REQUIRES ADDITIONAL DEMOLITION, SUPPORTING OF EXISTING STRUCTURES OR MAKING GOOD OF ZONES RESULTING IN THE DEMOLITION PROCESS, THE CONTRACTOR SHALL ALLOW FOR SUCH WORKS AS REQUIRED TO COMPLETE THE WORKS.

ALL EFFORTS HAVE BEEN MADE TO NOTE PRINCIPLE DEMOLITION

IT IS THE CONTRACTORS RESPONSIBILITY TO ENSURE THE WORKS ARE CONDUCTED IN ACCORDANCE WITH THE REQUIREMENTS OF LOCAL AUTHORITIES, APPROVED BUILDING PRACTICES AND ALL RELEVANT LEGISLATION

REFER TO SURVEY PLAN FOR EXISTING SITE CONDITIONS.

READ DEMOLITION DRAWINGS IN CONJUNCTION WITH STRUCTURAL ENGINEER'S DRAWINGS AND SPECIFICATIONS.

REFER TO SERVICES DRAWINGS FOR THE EXTENT OF ELECTRICAL, MECHANICAL AND HYDRAULIC SERVICES RELOCATION, DISCONNECTION OR REMOVAL. DECOMMISSION, CAP AND SEAL ALL SERVICES TO BE TERMINATED OR DISTURBED BY DEMOLITION WORKS. PLACE MARKERS TO INDICATE LOCATION OF DISCONNECTED SERVICES.

ALLOW FOR DRILLING/ CUTTING OF CORE HOLES AND SERVICES PENETRATIONS FOR ALL NEW SERVICES THROUGH EXISTING BUILDING ELEMENTS AS REQUIRED BY SERVICES ENGINEERING DOCUMENTATION.

MATERIAL LOADING & UNLOADING ON SITE RELATING TO THE DEMOLITION WORKS.

THE CONTRACTOR IS RESPONSIBLE FOR MANAGING ALL

IT IS THE CONTRACTOR'S RESPONSIBILITY TO REPAIR AND MAKE GOOD WATERPROOFING DISTURBED BY DEMOLITION WORKS AND

MARRY IN AND MAKE GOOD WITH THE NEW WORK

PROVIDE AND MAINTAIN HOARDING, BARRICADES, LIGHTING AND GUARDRAILS AS REQUIRED BY APPLICABLE CODES AND WORKERS. COMPLY WITH ALL REGULATIONS PERTAINING TO SAFETY OF PERSONS, PROPERTY AND THE ENVIRONMENT

LEAVE CONTRACT AREAS AND SITE CLEAN, ORDERLY AND ACCEPTABLE FOR NEW CONSTRUCTION. ALL SURFACES TO BE LEFT IN GOOD ORDER, MAKE GOOD AND PROFESSIONALLY REPAIR ALL HOLES WEATHER TIGHT AND TO EQUIVALENT FIRE RATING OF SURROUNDING CONSTRUCTION AS REQUIRED.

PREVENT MOVEMENT OR SETTLEMENT OF STRUCTURE(S) PROVIDE AND PLACE BRACING OR SHORING IN ACCORDANCE WITH STRUCTURAL ENGINEER'S DETAILS AND BE RESPONSIBLE FOR SAFETY AND SUPPORT OF STRUCTURE DURING THE WORKS. ASSUME LIABILITY FOR SUCH MOVEMENT, SETTLEMENT, DAMAGE

THE CONTRACTOR IS TO ALLOW FOR THE REMOVAL AND

DISPOSAL OF ALL DEMOLISHED MATERIALS, DEBRIS, REFUSE AND RUBBISH ASSOCIATED WITH THE DEMOLITION WORKS. CLIENT:

CONYBEARE MORRISON INTERNATIONAL P\L | ABN 50 055 972 248

T | 61 2 8244 8888 W | www.cmplus.com.au E | mail@cmplus.com.au

Darrel Conybeare NSW ARB No 2252 | Bill Morrison NSW ARB No 2447

**BOMADERRY BASKETBALL STADIUM** 

84 CAMBEWARRA RD, BOMADERRY,

**DEMOLITION PLAN - GROUND LEVEL** 

0 SCALE 1:100 4

SCALE: As indicated @

REV:



ARCHITECT:

PROJECT:

NSW 2541

**DA0101** 

REFURBISHMENT

DRAWING TITLE:

ASBESTOS AND CONTAMINATED MATERIALS. FLOOR BOARDS TO BE REMOVED, STORED

11. STAIRS TO REFEREE PLATFORM TO BE 12. RED SHADE DENOTES EXISTING VINYL / TILED FLOOR FINISHES TO AMENITIES CORE TO BE

13. REMOVE EXISTING INTERNAL WALL STUDS, LININGS WITH CARE, AND DISPOSED SAFELY WHICH MAY CONTAIN ASBESTOS AND

14. REMOVE EXISTING SANITARY FIXTURES AND JOINERY. SEAL AND CAP EX PLUMBING OUTLETS AND MAKE GOOD FLOOR FINISHES ON SITE. REFER TO HYDRAULIC ENGINNER FOR DEMOLITION REQUIREMENT OF NON

15. REMOVE ALL EXISTING EXTERNAL AND INTERNAL DOORS AND HARDWARE. 16. REMOVE EXISTING SPECTATOR SEATING AND FOOTING FRAME STRUCTURE WITH CARE, ASBESTOS AND CONTAMINATED MATERIALS

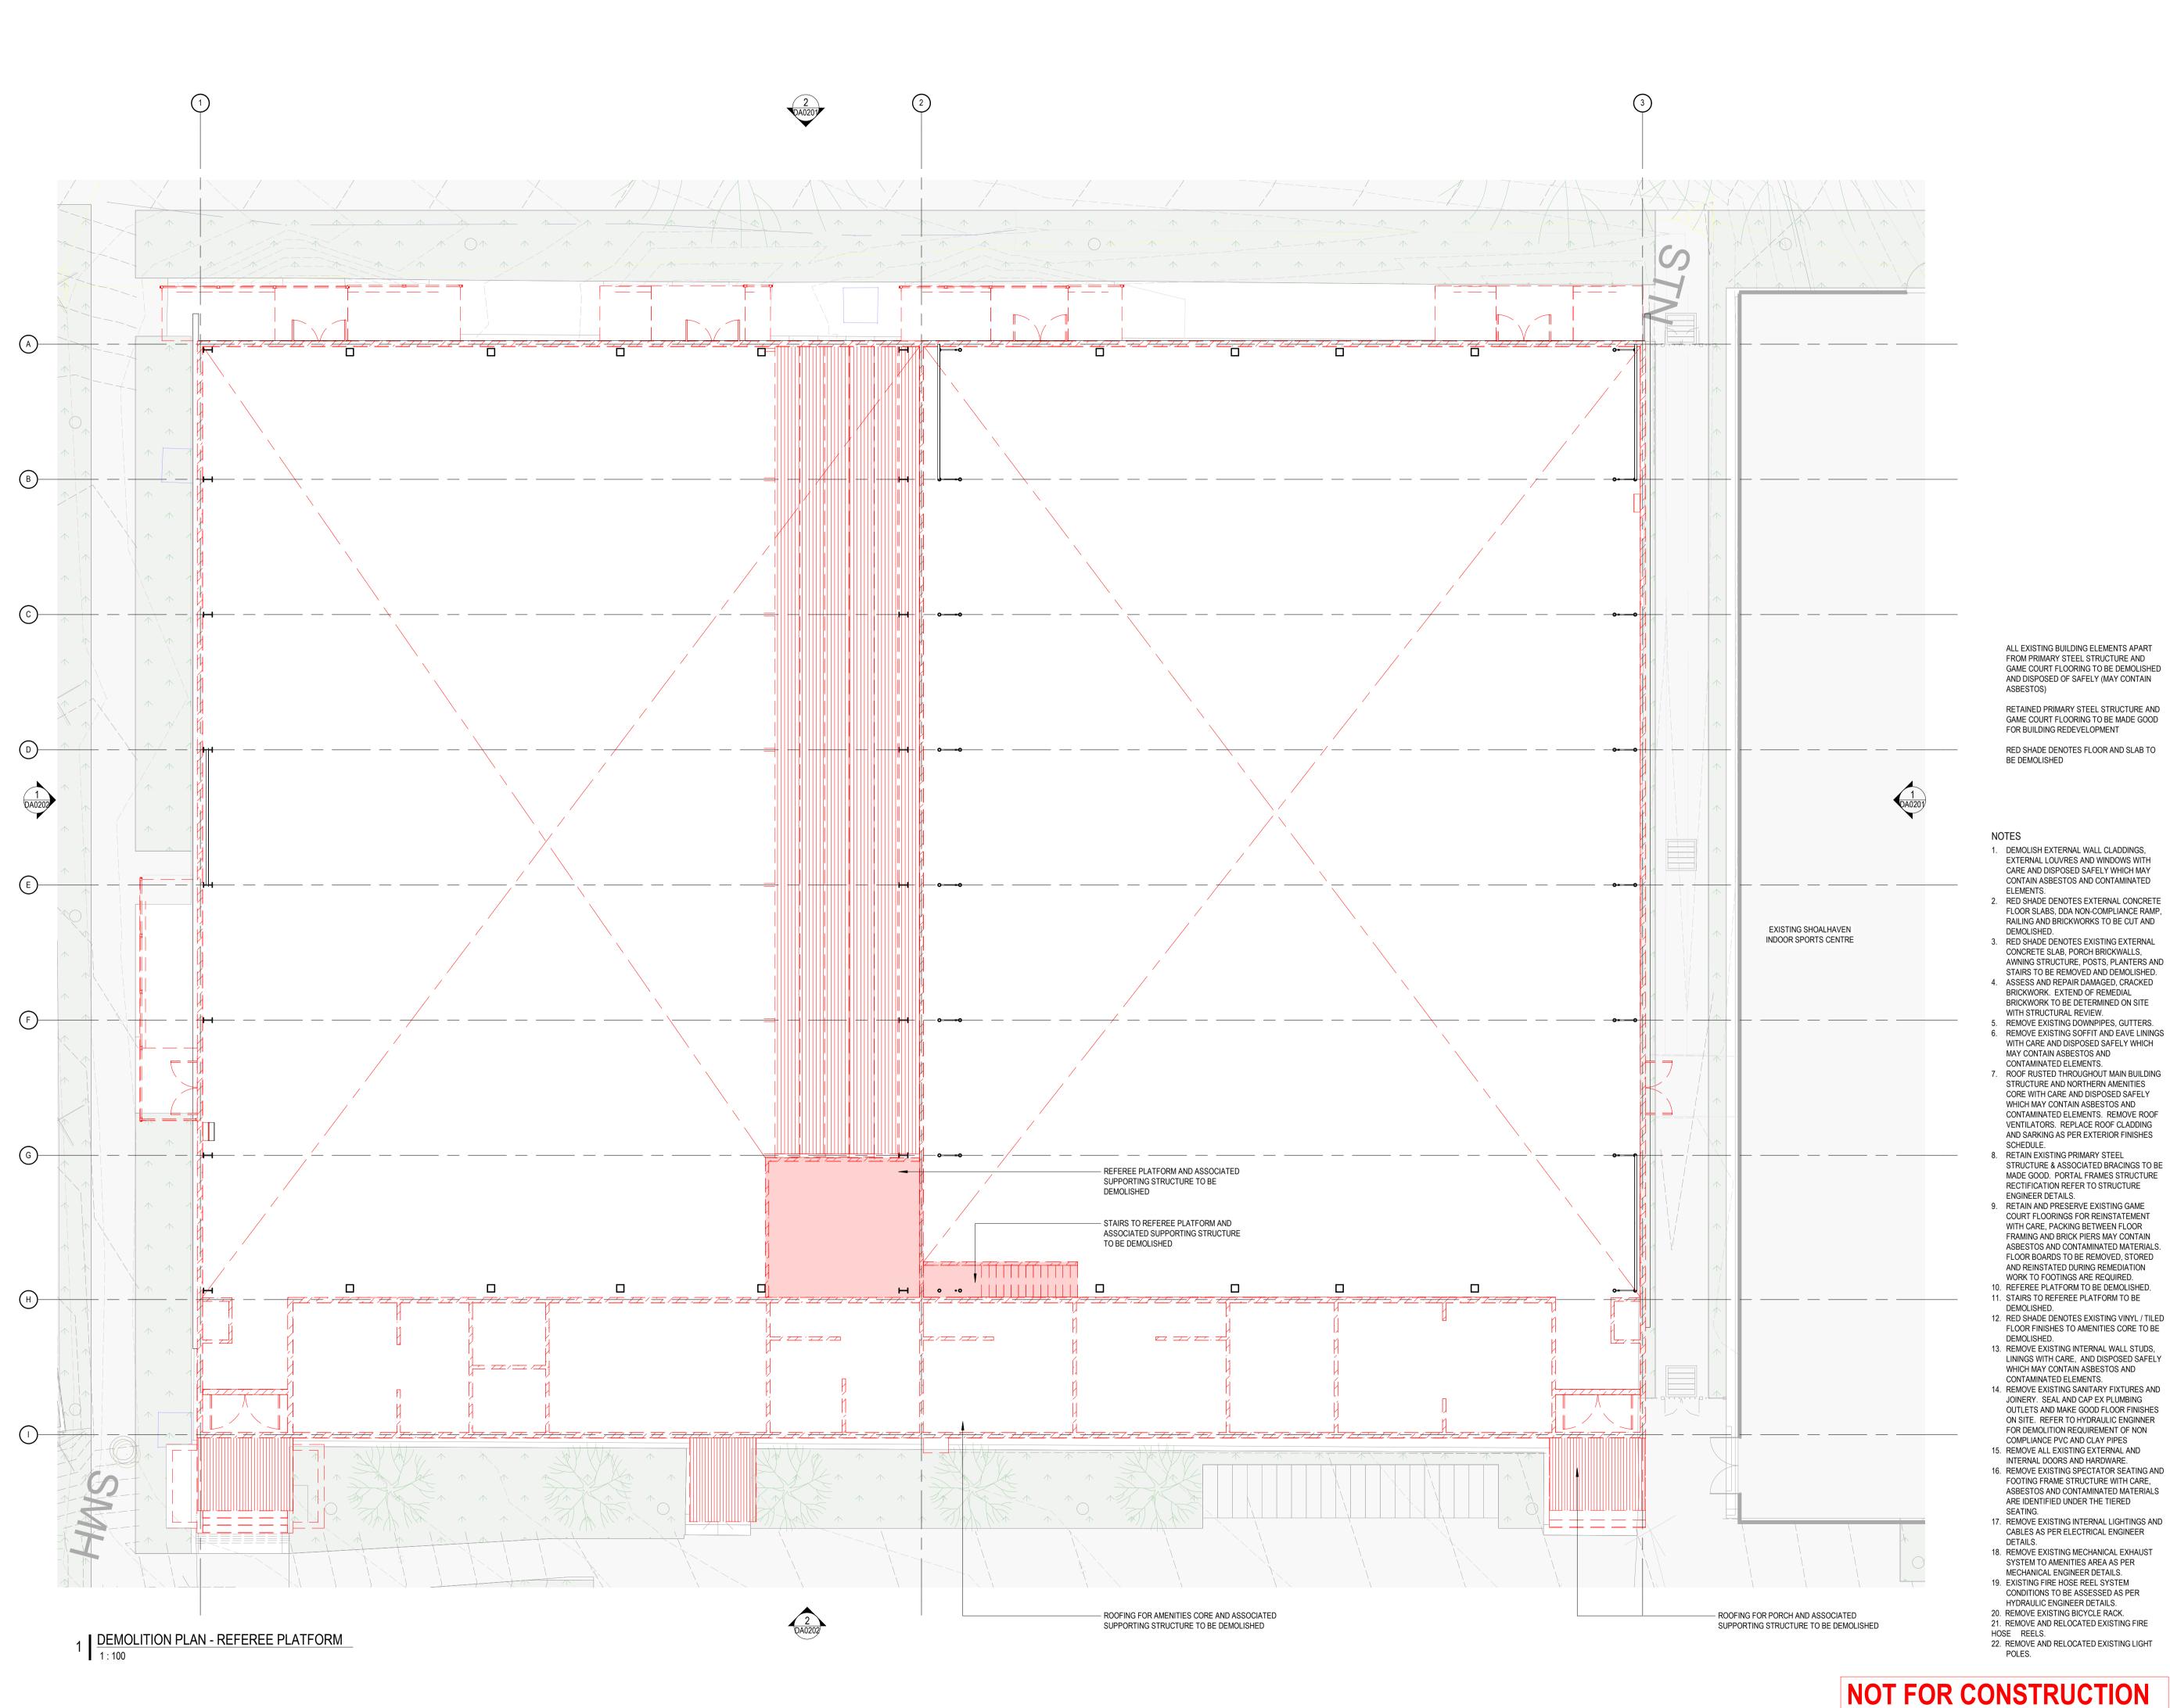
17. REMOVE EXISTING INTERNAL LIGHTINGS AND

CABLES AS PER ELECTRICAL ENGINEER 18. REMOVE EXISTING MECHANICAL EXHAUST

MECHANICAL ENGINEER DETAILS. 19. EXISTING FIRE HOSE REEL SYSTEM CONDITIONS TO BE ASSESSED AS PER HYDRAULIC ENGINEER DETAILS.

20. REMOVE EXISTING BICYCLE RACK. 21. REMOVE AND RELOCATED EXISTING FIRE SHEET NUMBER:

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WALL LEGEND

CONCRETE WORK **EXISTING ELEMENT** BRICKWORK DEMOLISHED ELEMENT

BLOCKWORK

**DEMOLITION NOTES** 

VERIFY ALL EXISTING CONDITIONS ON SITE PRIOR TO COMMENCING. NOTIFY ARCHITECT IF SITE CONDITIONS VARY FROM DRAWINGS.

ALL EFFORTS HAVE BEEN MADE TO NOTE PRINCIPLE DEMOLITION REQUIREMENT / WORKS. WHERE THE CONTRACTOR REQUIRES ADDITIONAL DEMOLITION, SUPPORTING OF EXISTING STRUCTURES OR MAKING GOOD OF ZONES RESULTING IN THE DEMOLITION PROCESS, THE CONTRACTOR SHALL ALLOW FOR SUCH WORKS AS REQUIRED TO COMPLETE THE WORKS.

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PROVIDE AND MAINTAIN HOARDING, BARRICADES, LIGHTING AND GUARDRAILS AS REQUIRED BY APPLICABLE CODES AND REGULATIONS TO PROTECT OCCUPANTS OF BUILDING AND

WORKERS. COMPLY WITH ALL REGULATIONS PERTAINING TO SAFETY OF PERSONS, PROPERTY AND THE ENVIRONMENT LEAVE CONTRACT AREAS AND SITE CLEAN, ORDERLY AND ACCEPTABLE FOR NEW CONSTRUCTION. ALL SURFACES TO BE

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ARCHITECT:

12. RED SHADE DENOTES EXISTING VINYL / TILED FLOOR FINISHES TO AMENITIES CORE TO BE

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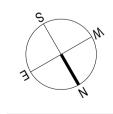
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21. REMOVE AND RELOCATED EXISTING FIRE



SCALE: As indicated @

0 SCALE 1:100 4

REV:

PROJECT:

**BOMADERRY BASKETBALL STADIUM** 

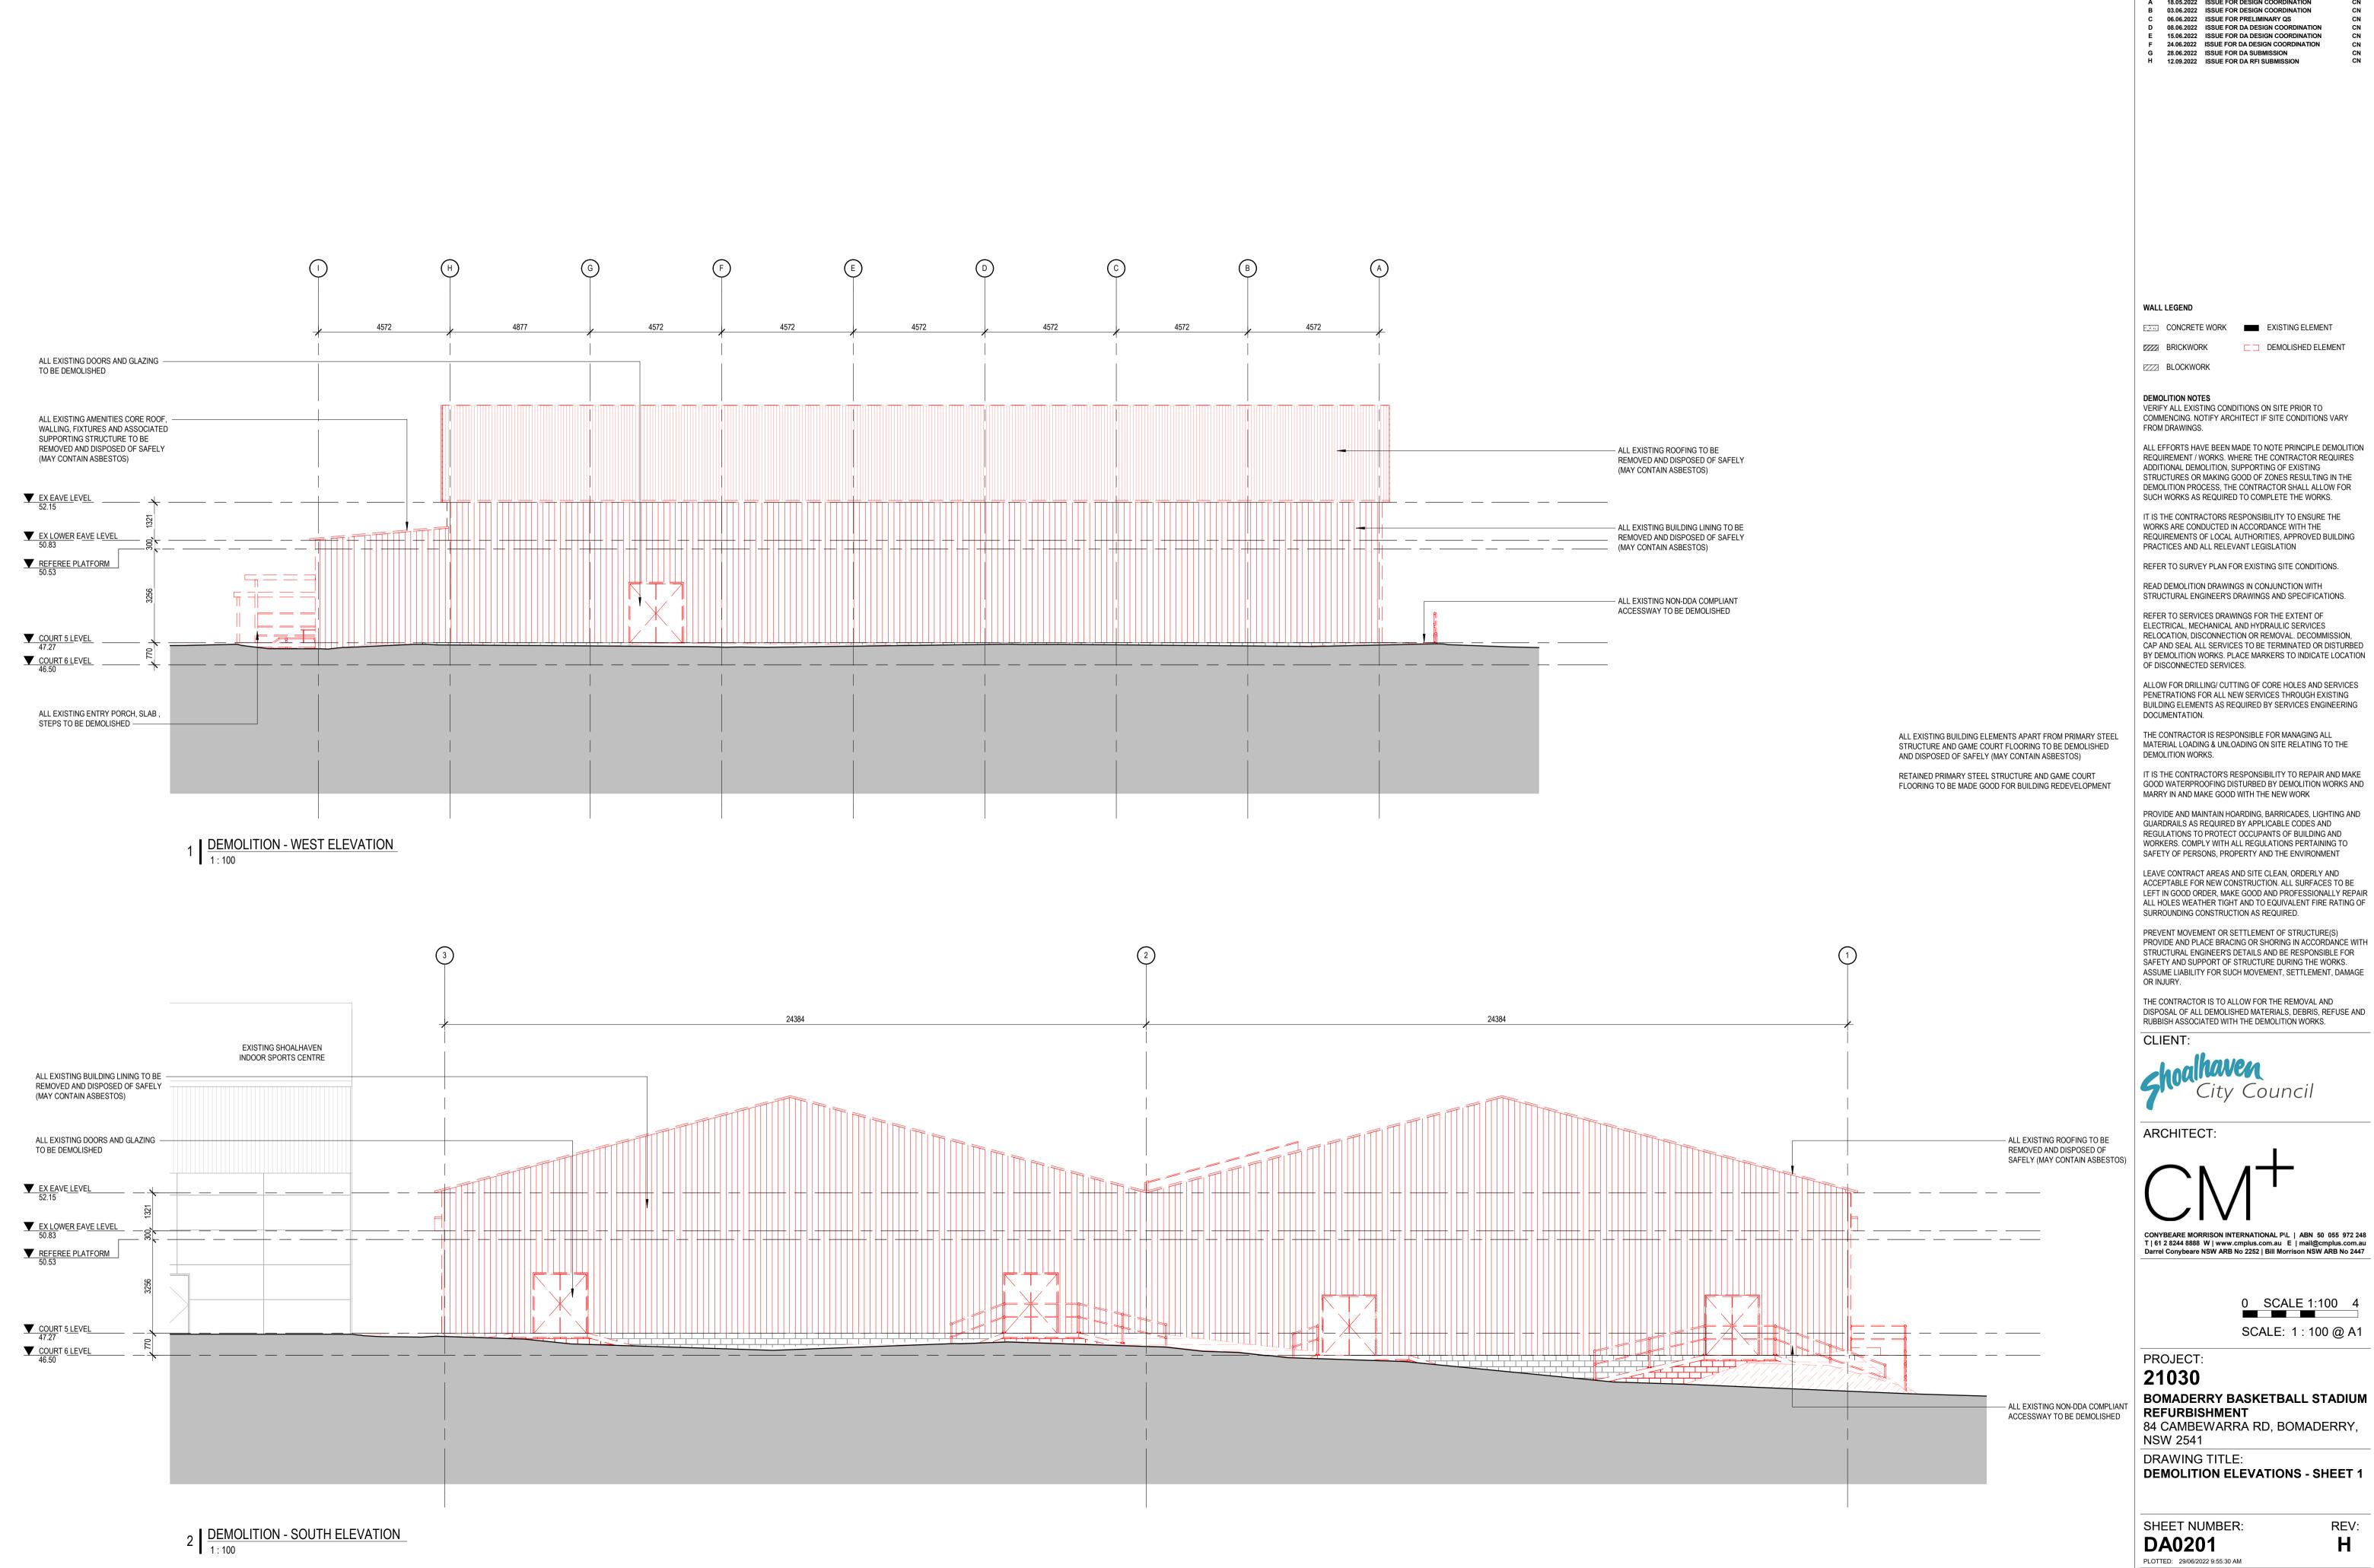
REFURBISHMENT 84 CAMBEWARRA RD, BOMADERRY, NSW 2541

DRAWING TITLE: **DEMOLITION PLAN - REFEREE PLATFORM** 

SHEET NUMBER: **DA0102** 

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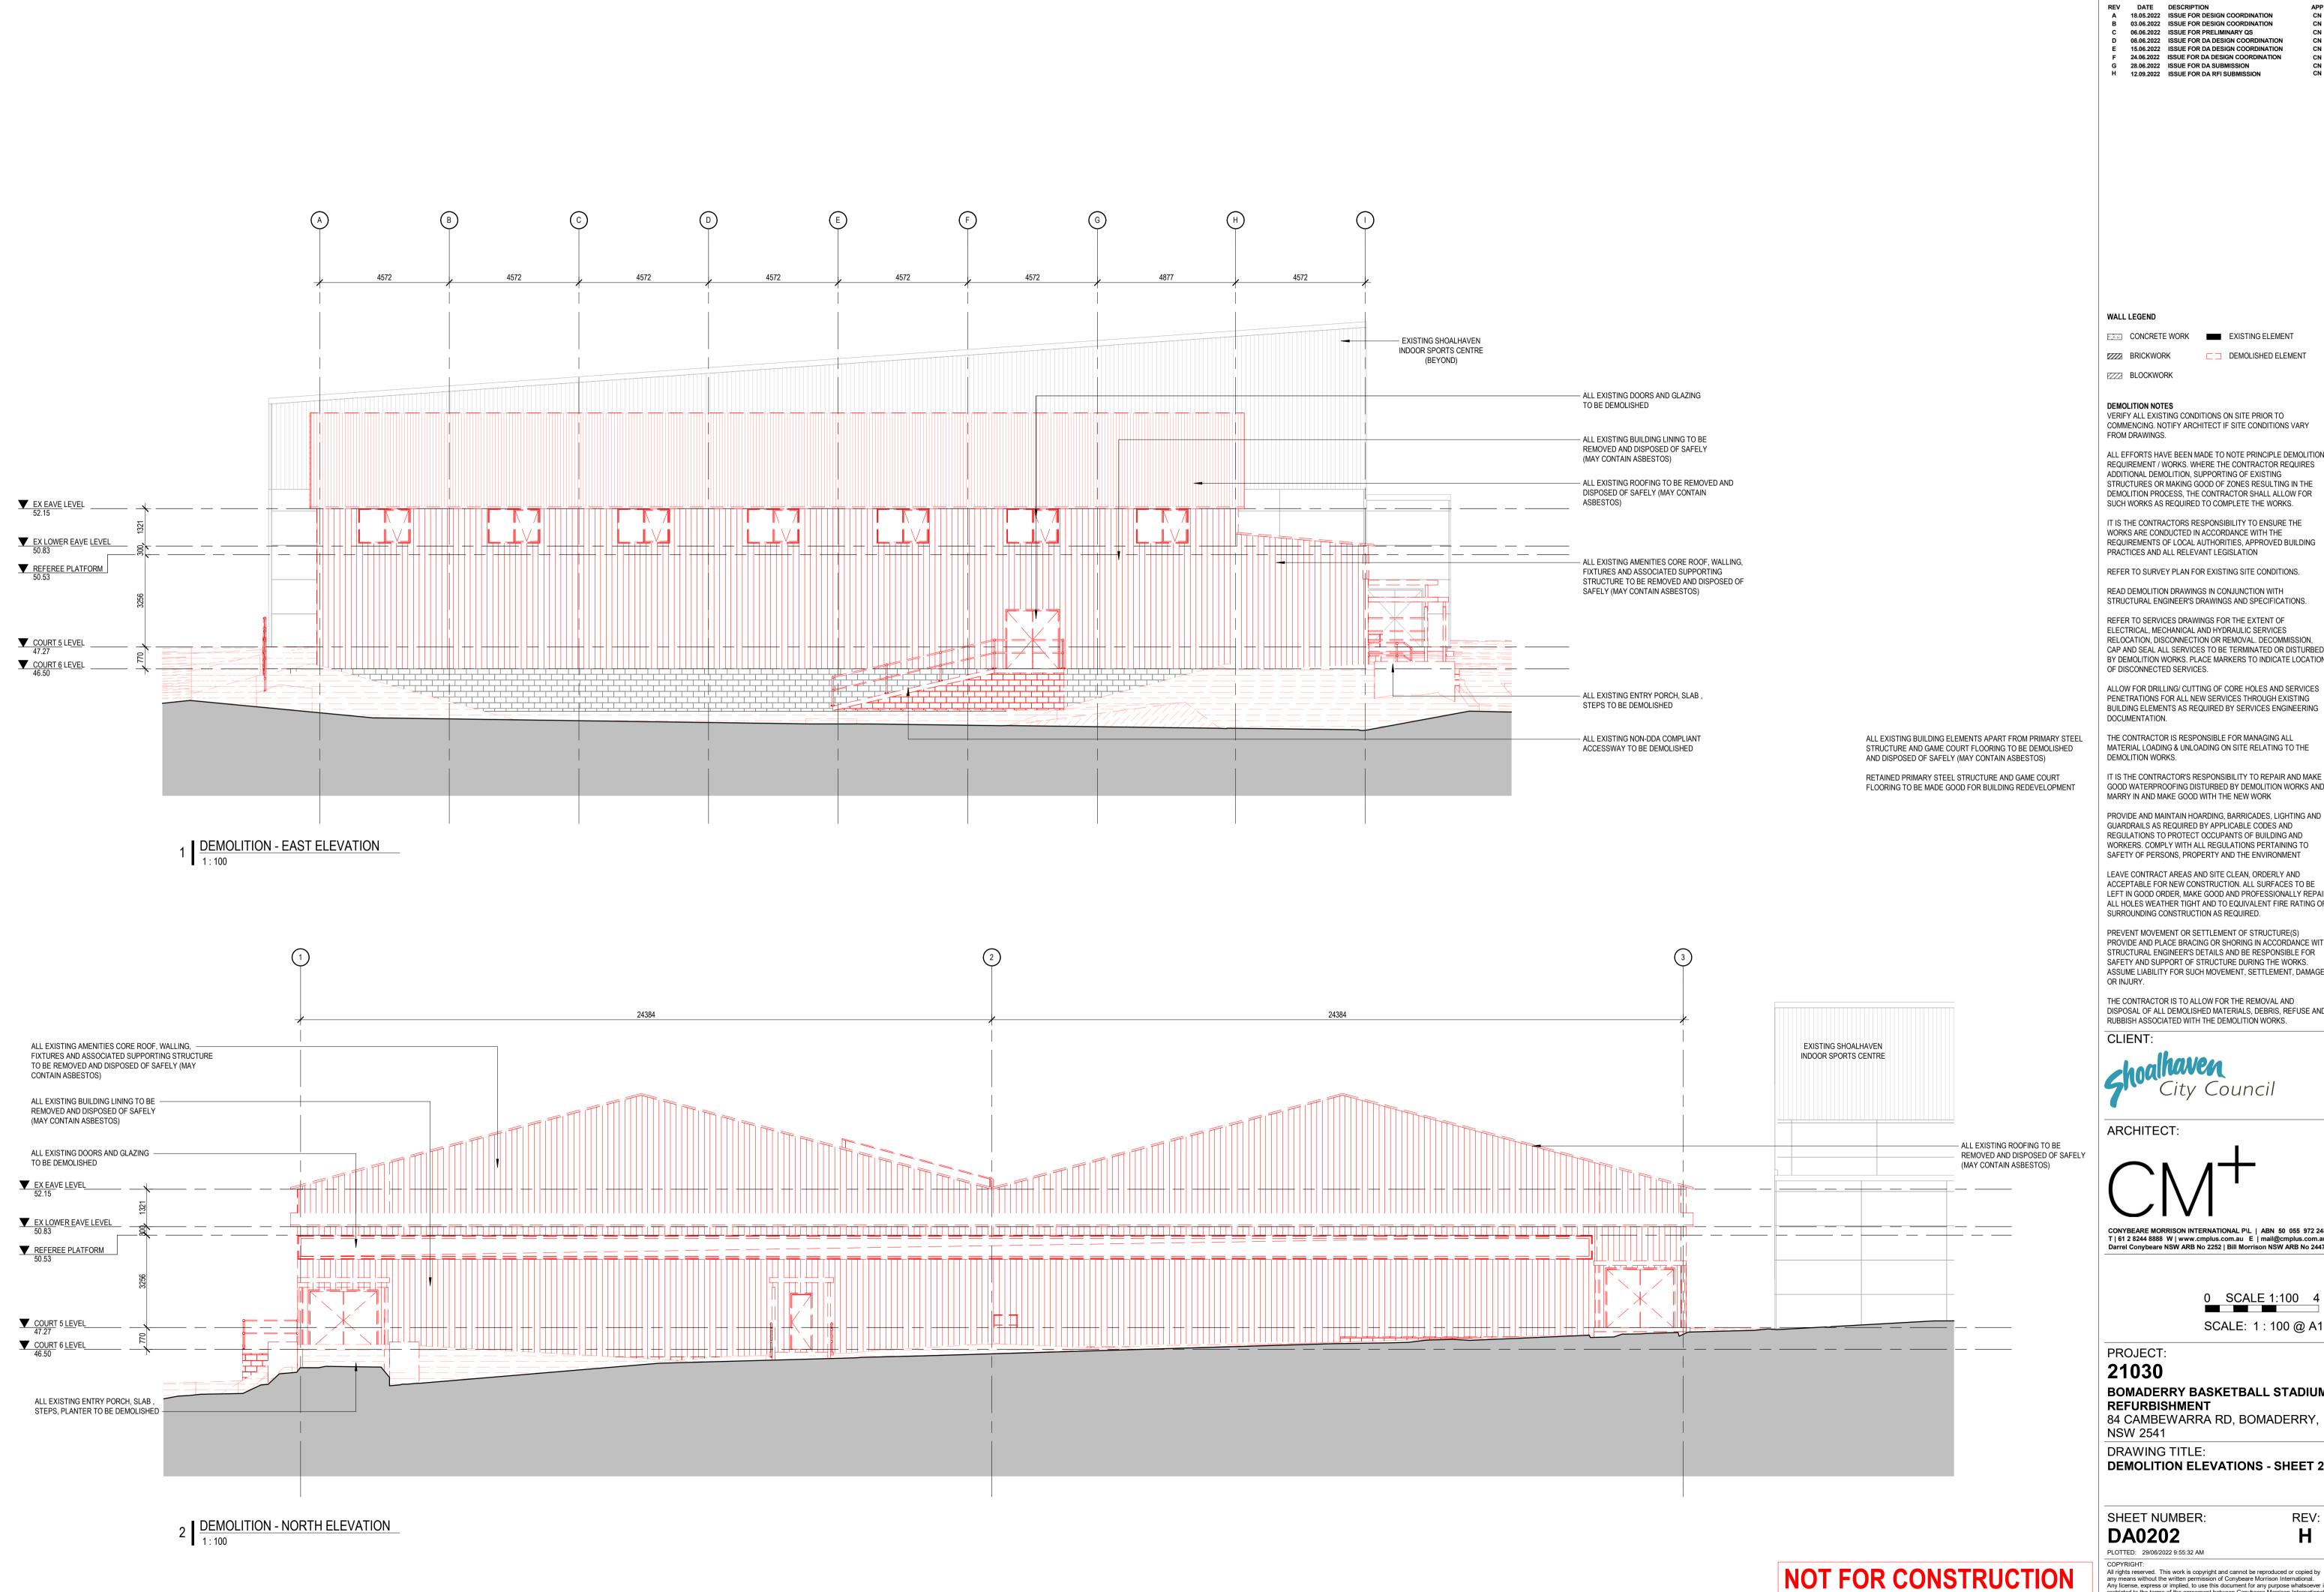
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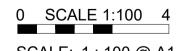
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SCALE: 1:100@A1

REV:

BOMADERRY BASKETBALL STADIUM **REFURBISHMENT** 84 CAMBEWARRA RD, BOMADERRY,

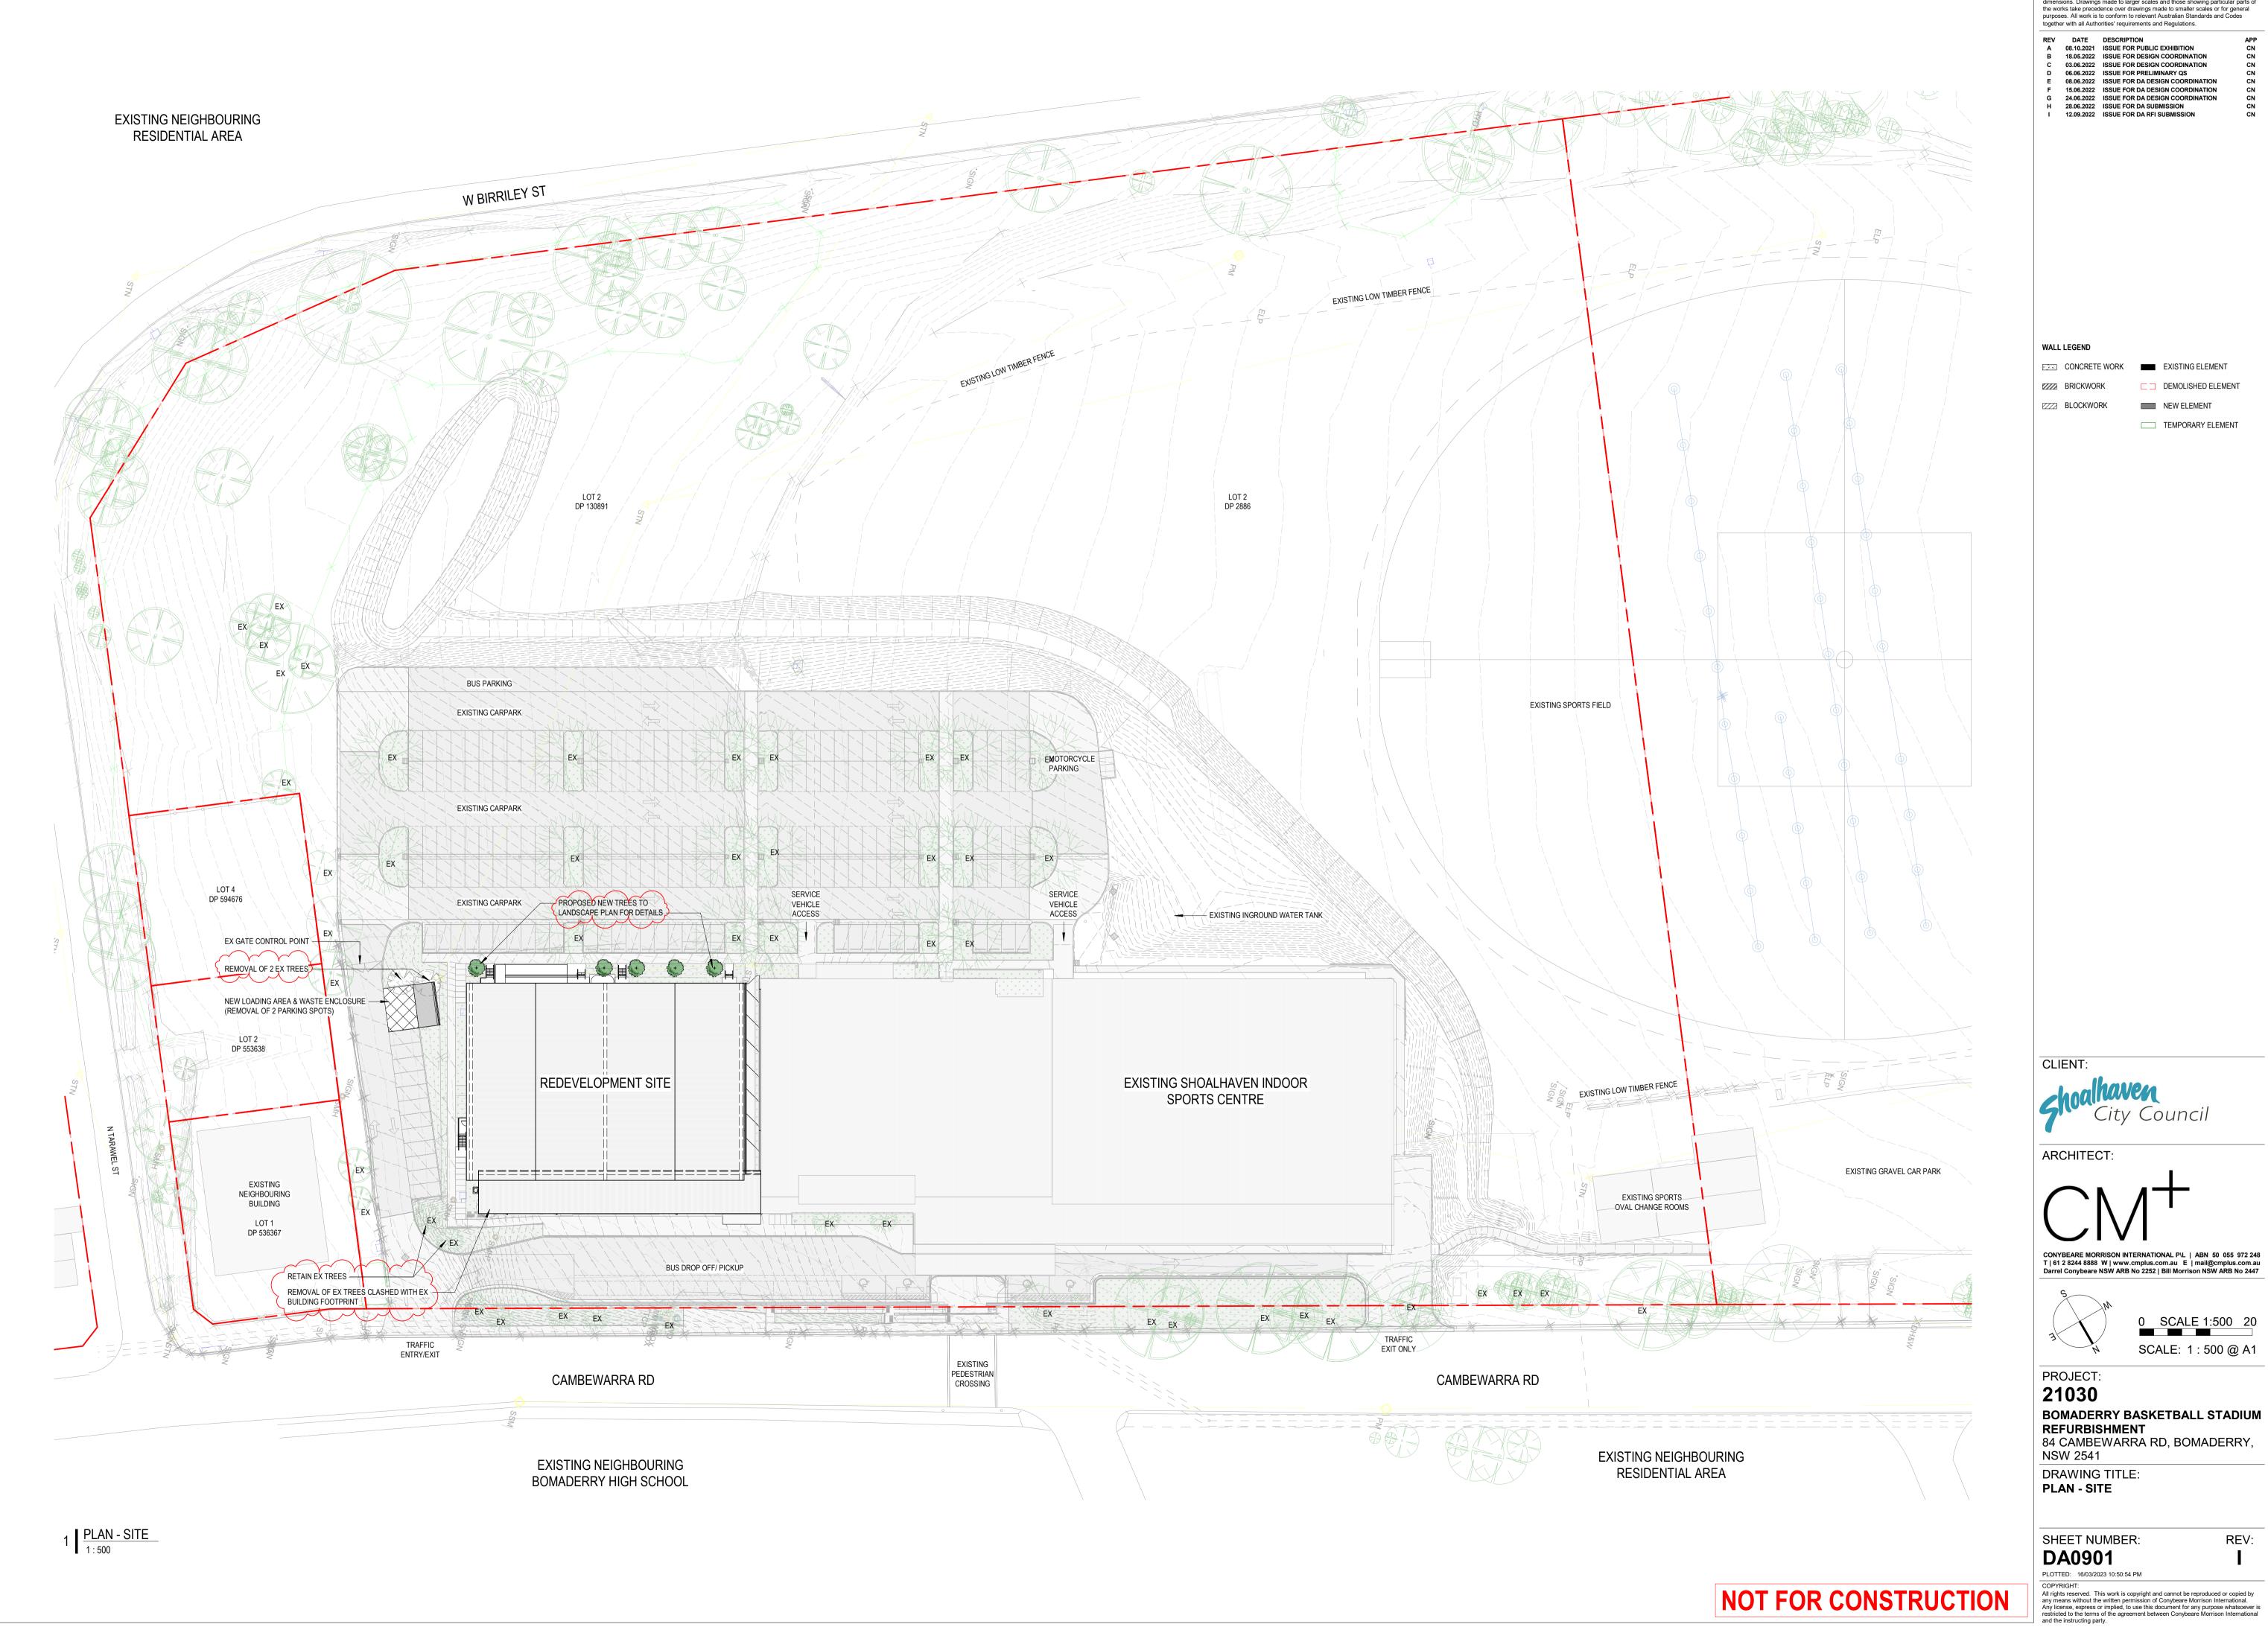
DRAWING TITLE:

**DEMOLITION ELEVATIONS - SHEET 2** 

**DA0202** 

PLOTTED: 29/06/2022 9:55:32 AM

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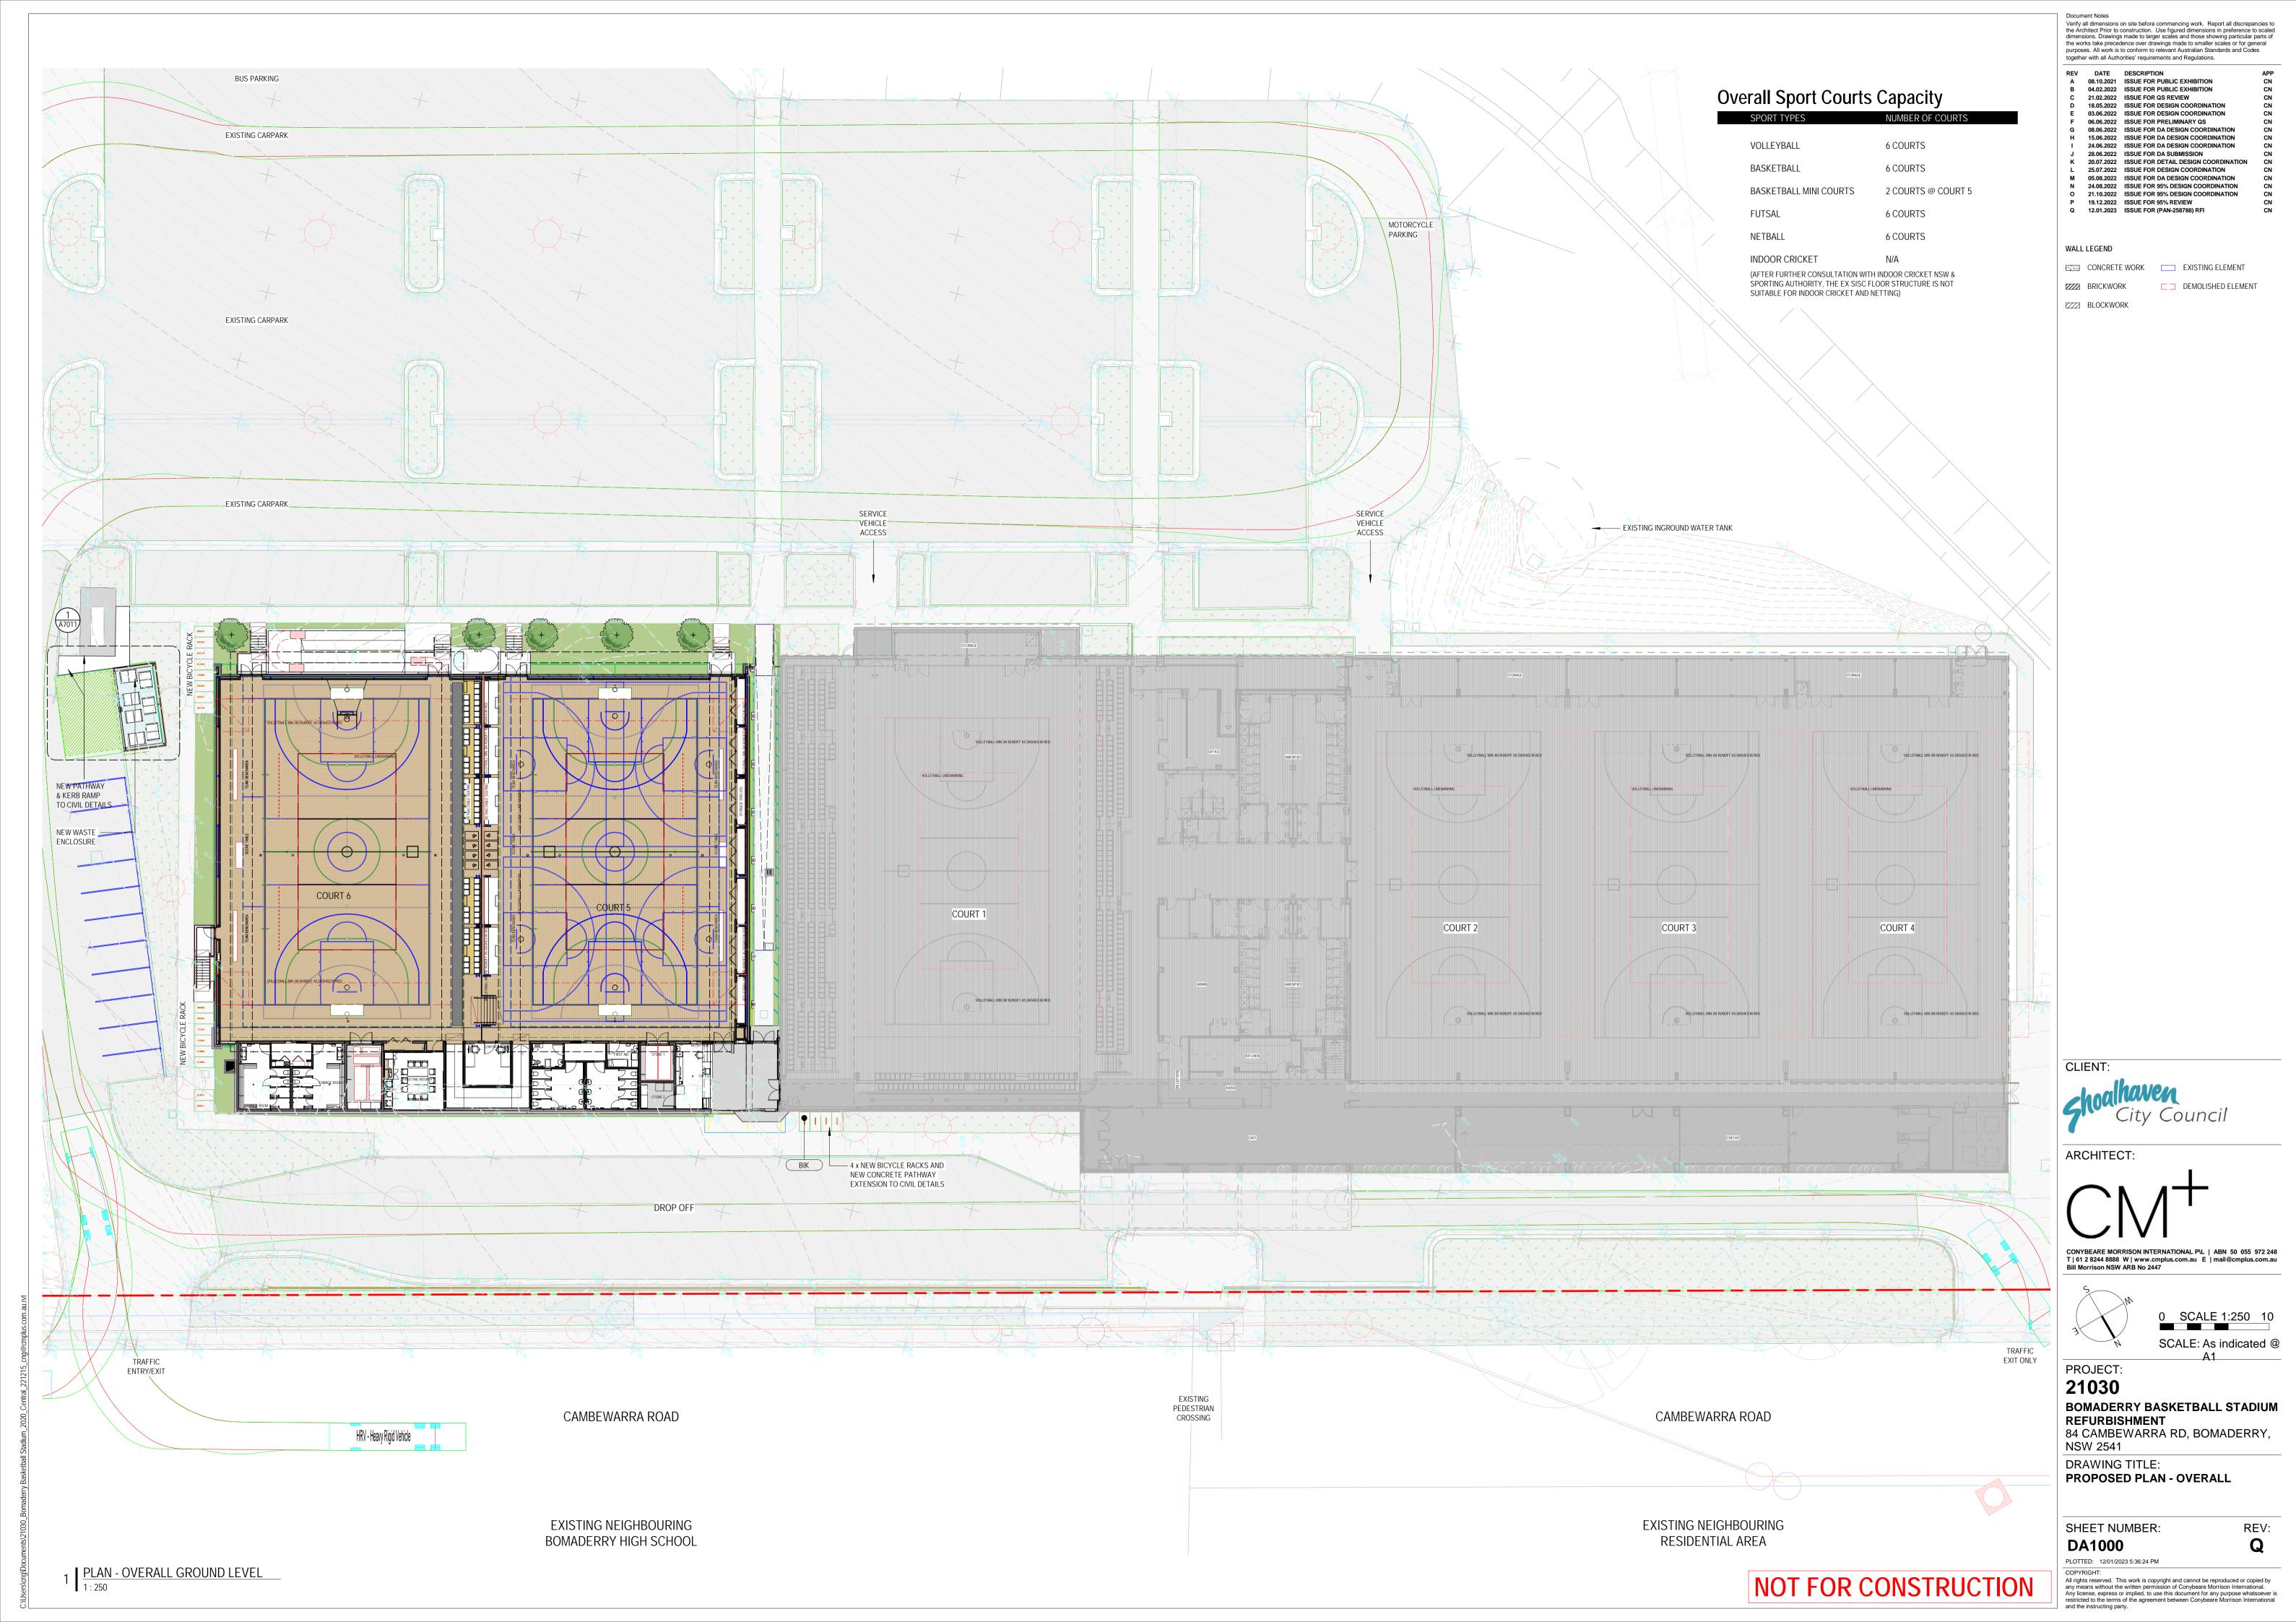


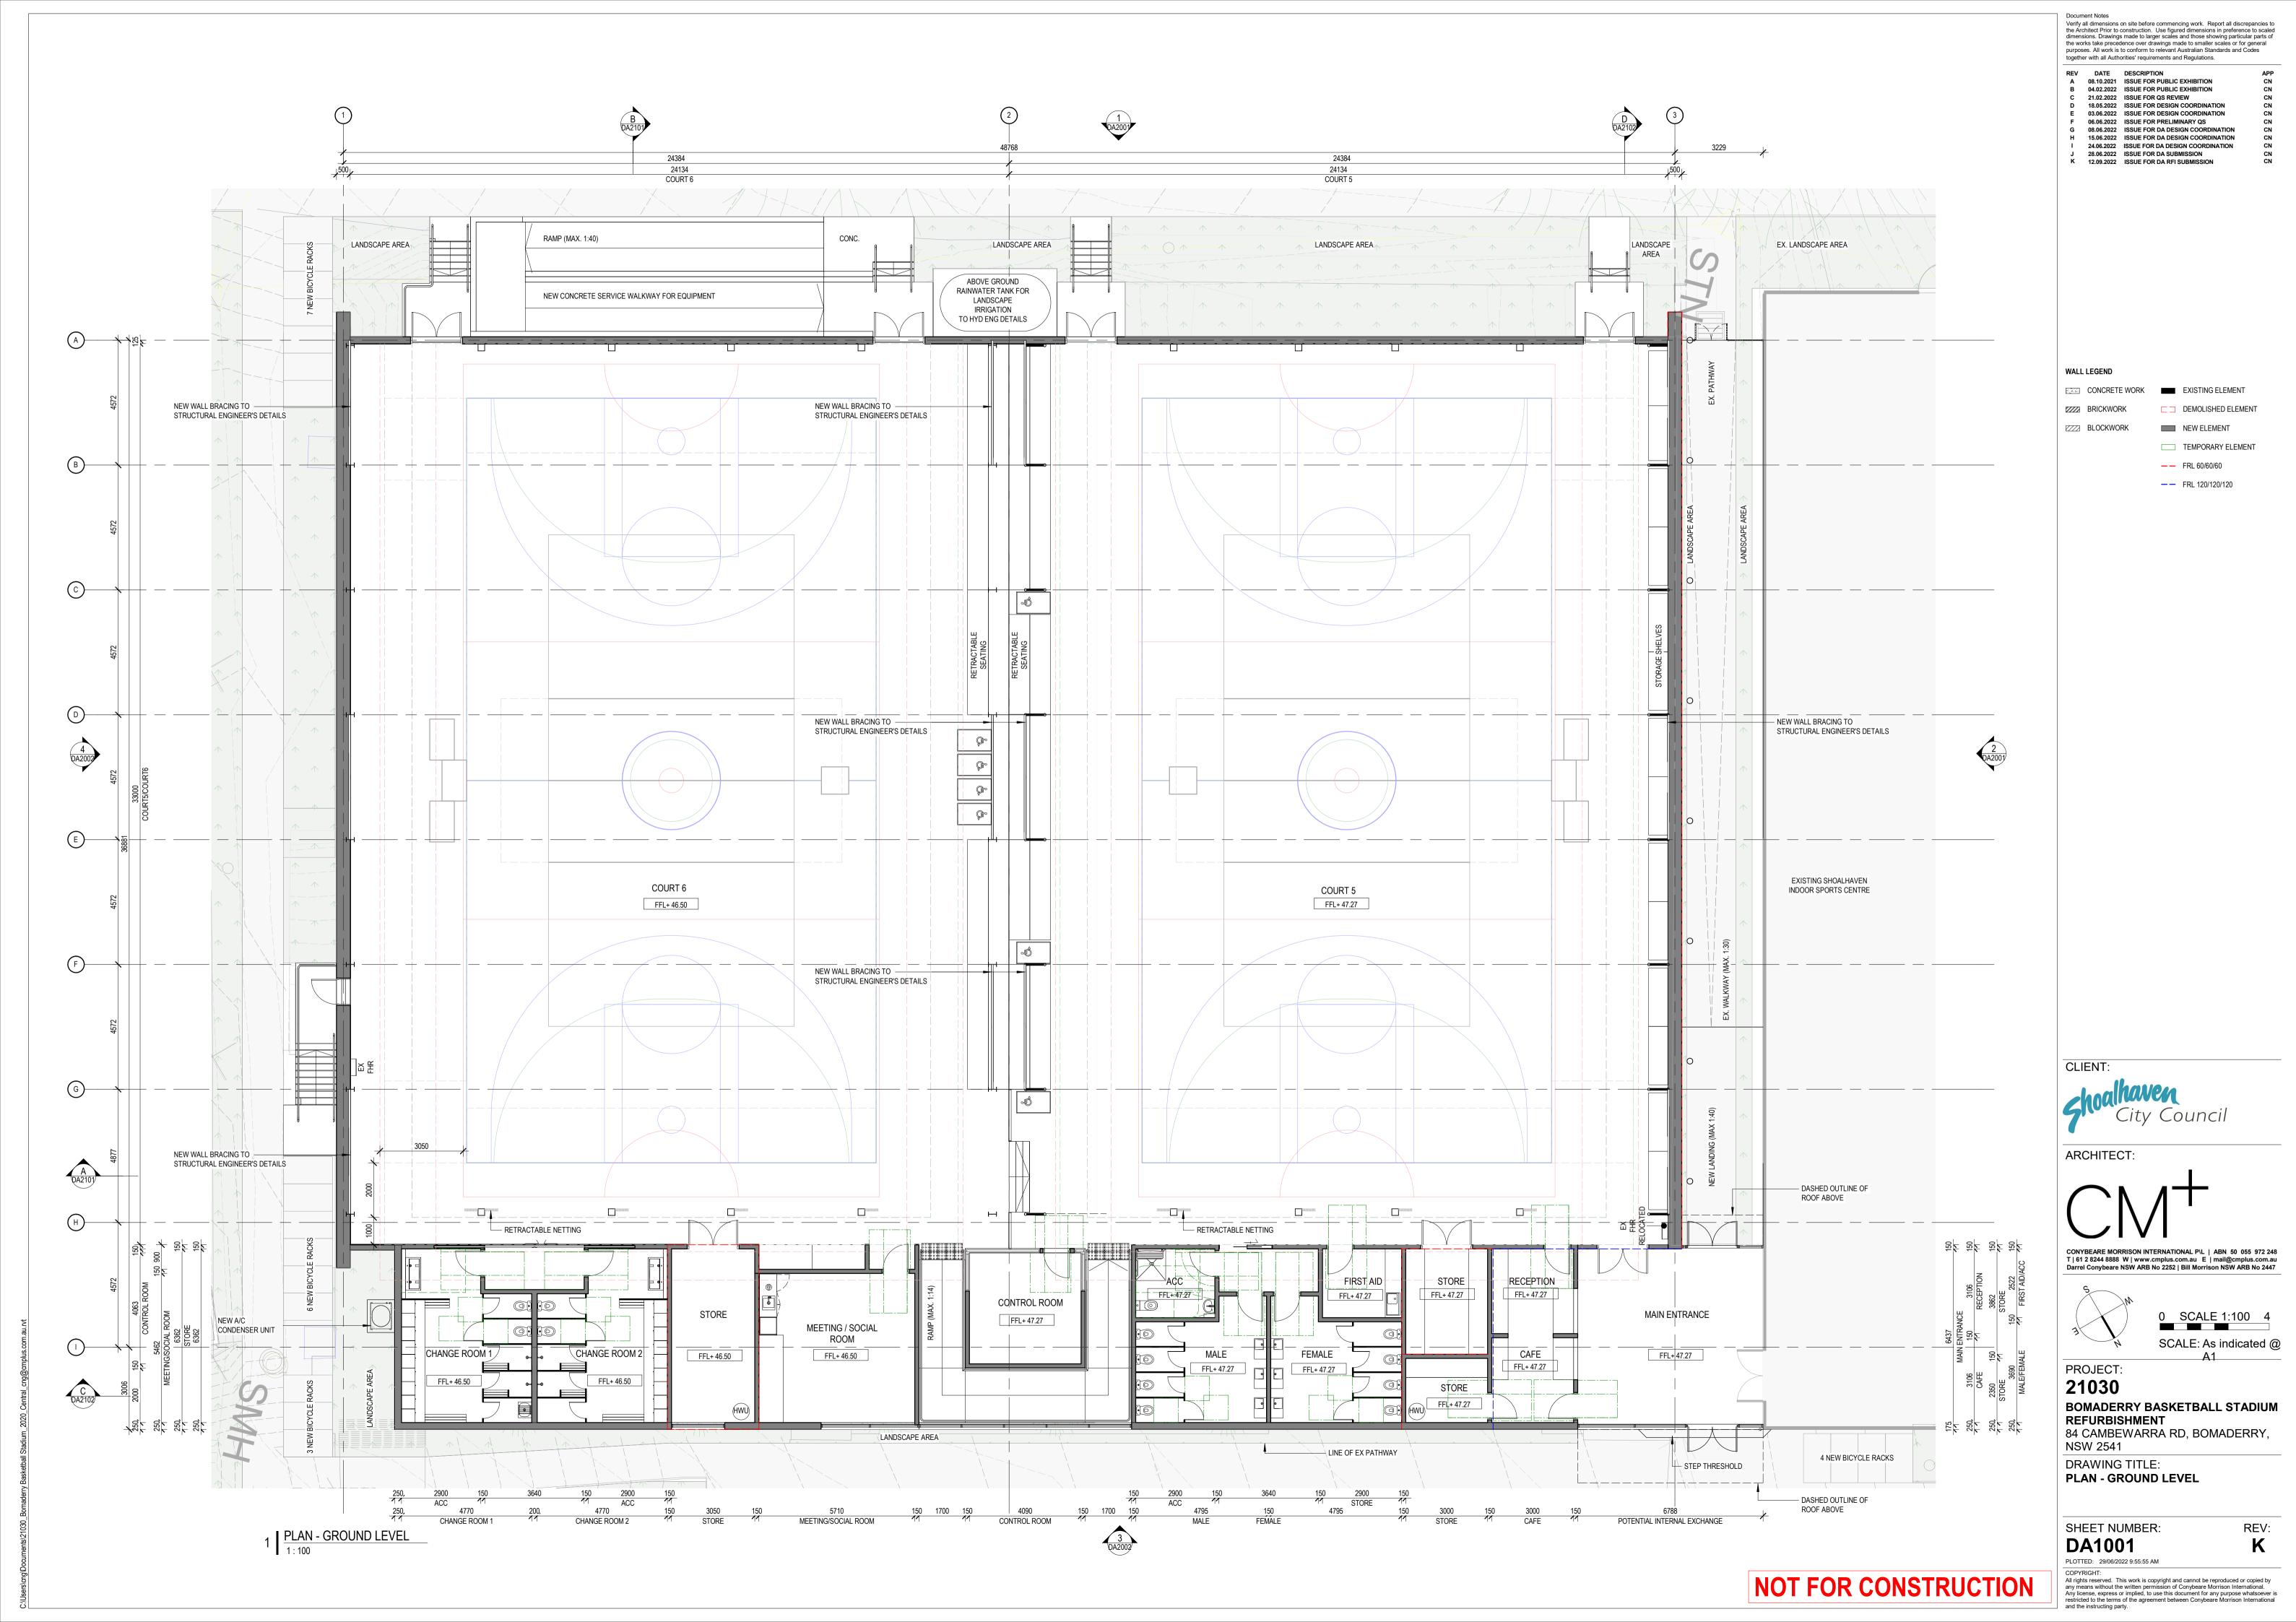
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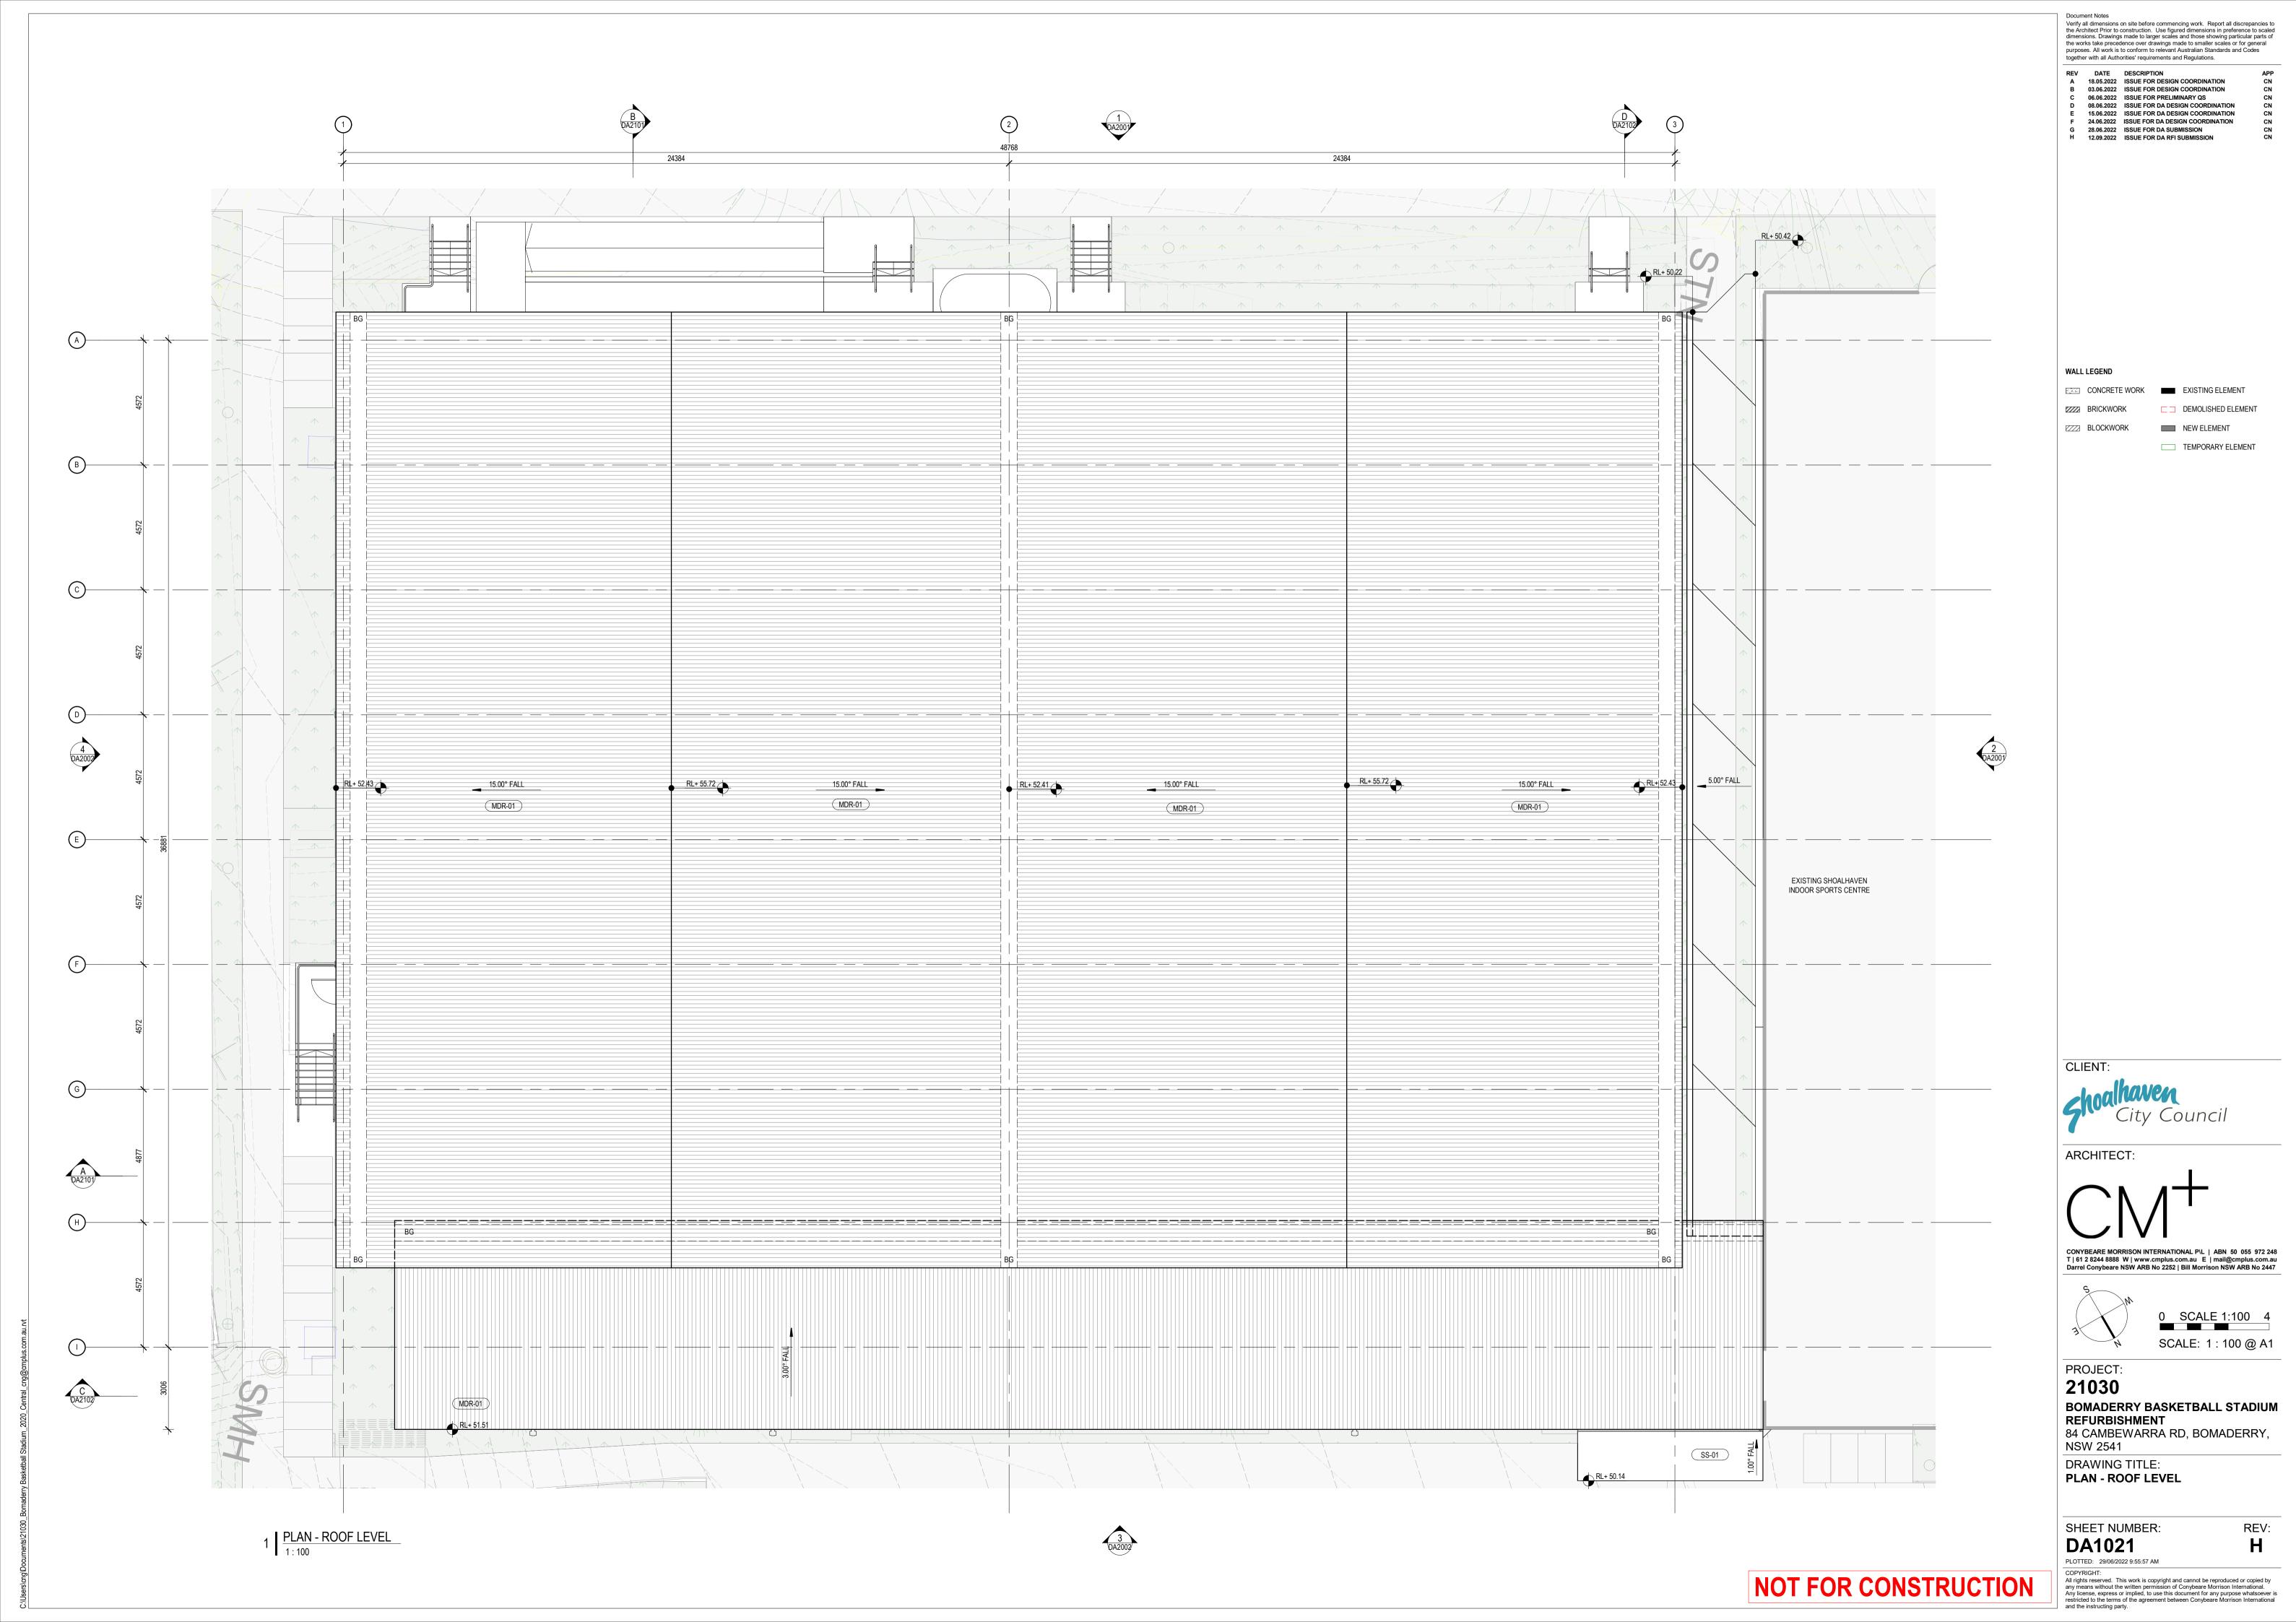
Voctorient Notes

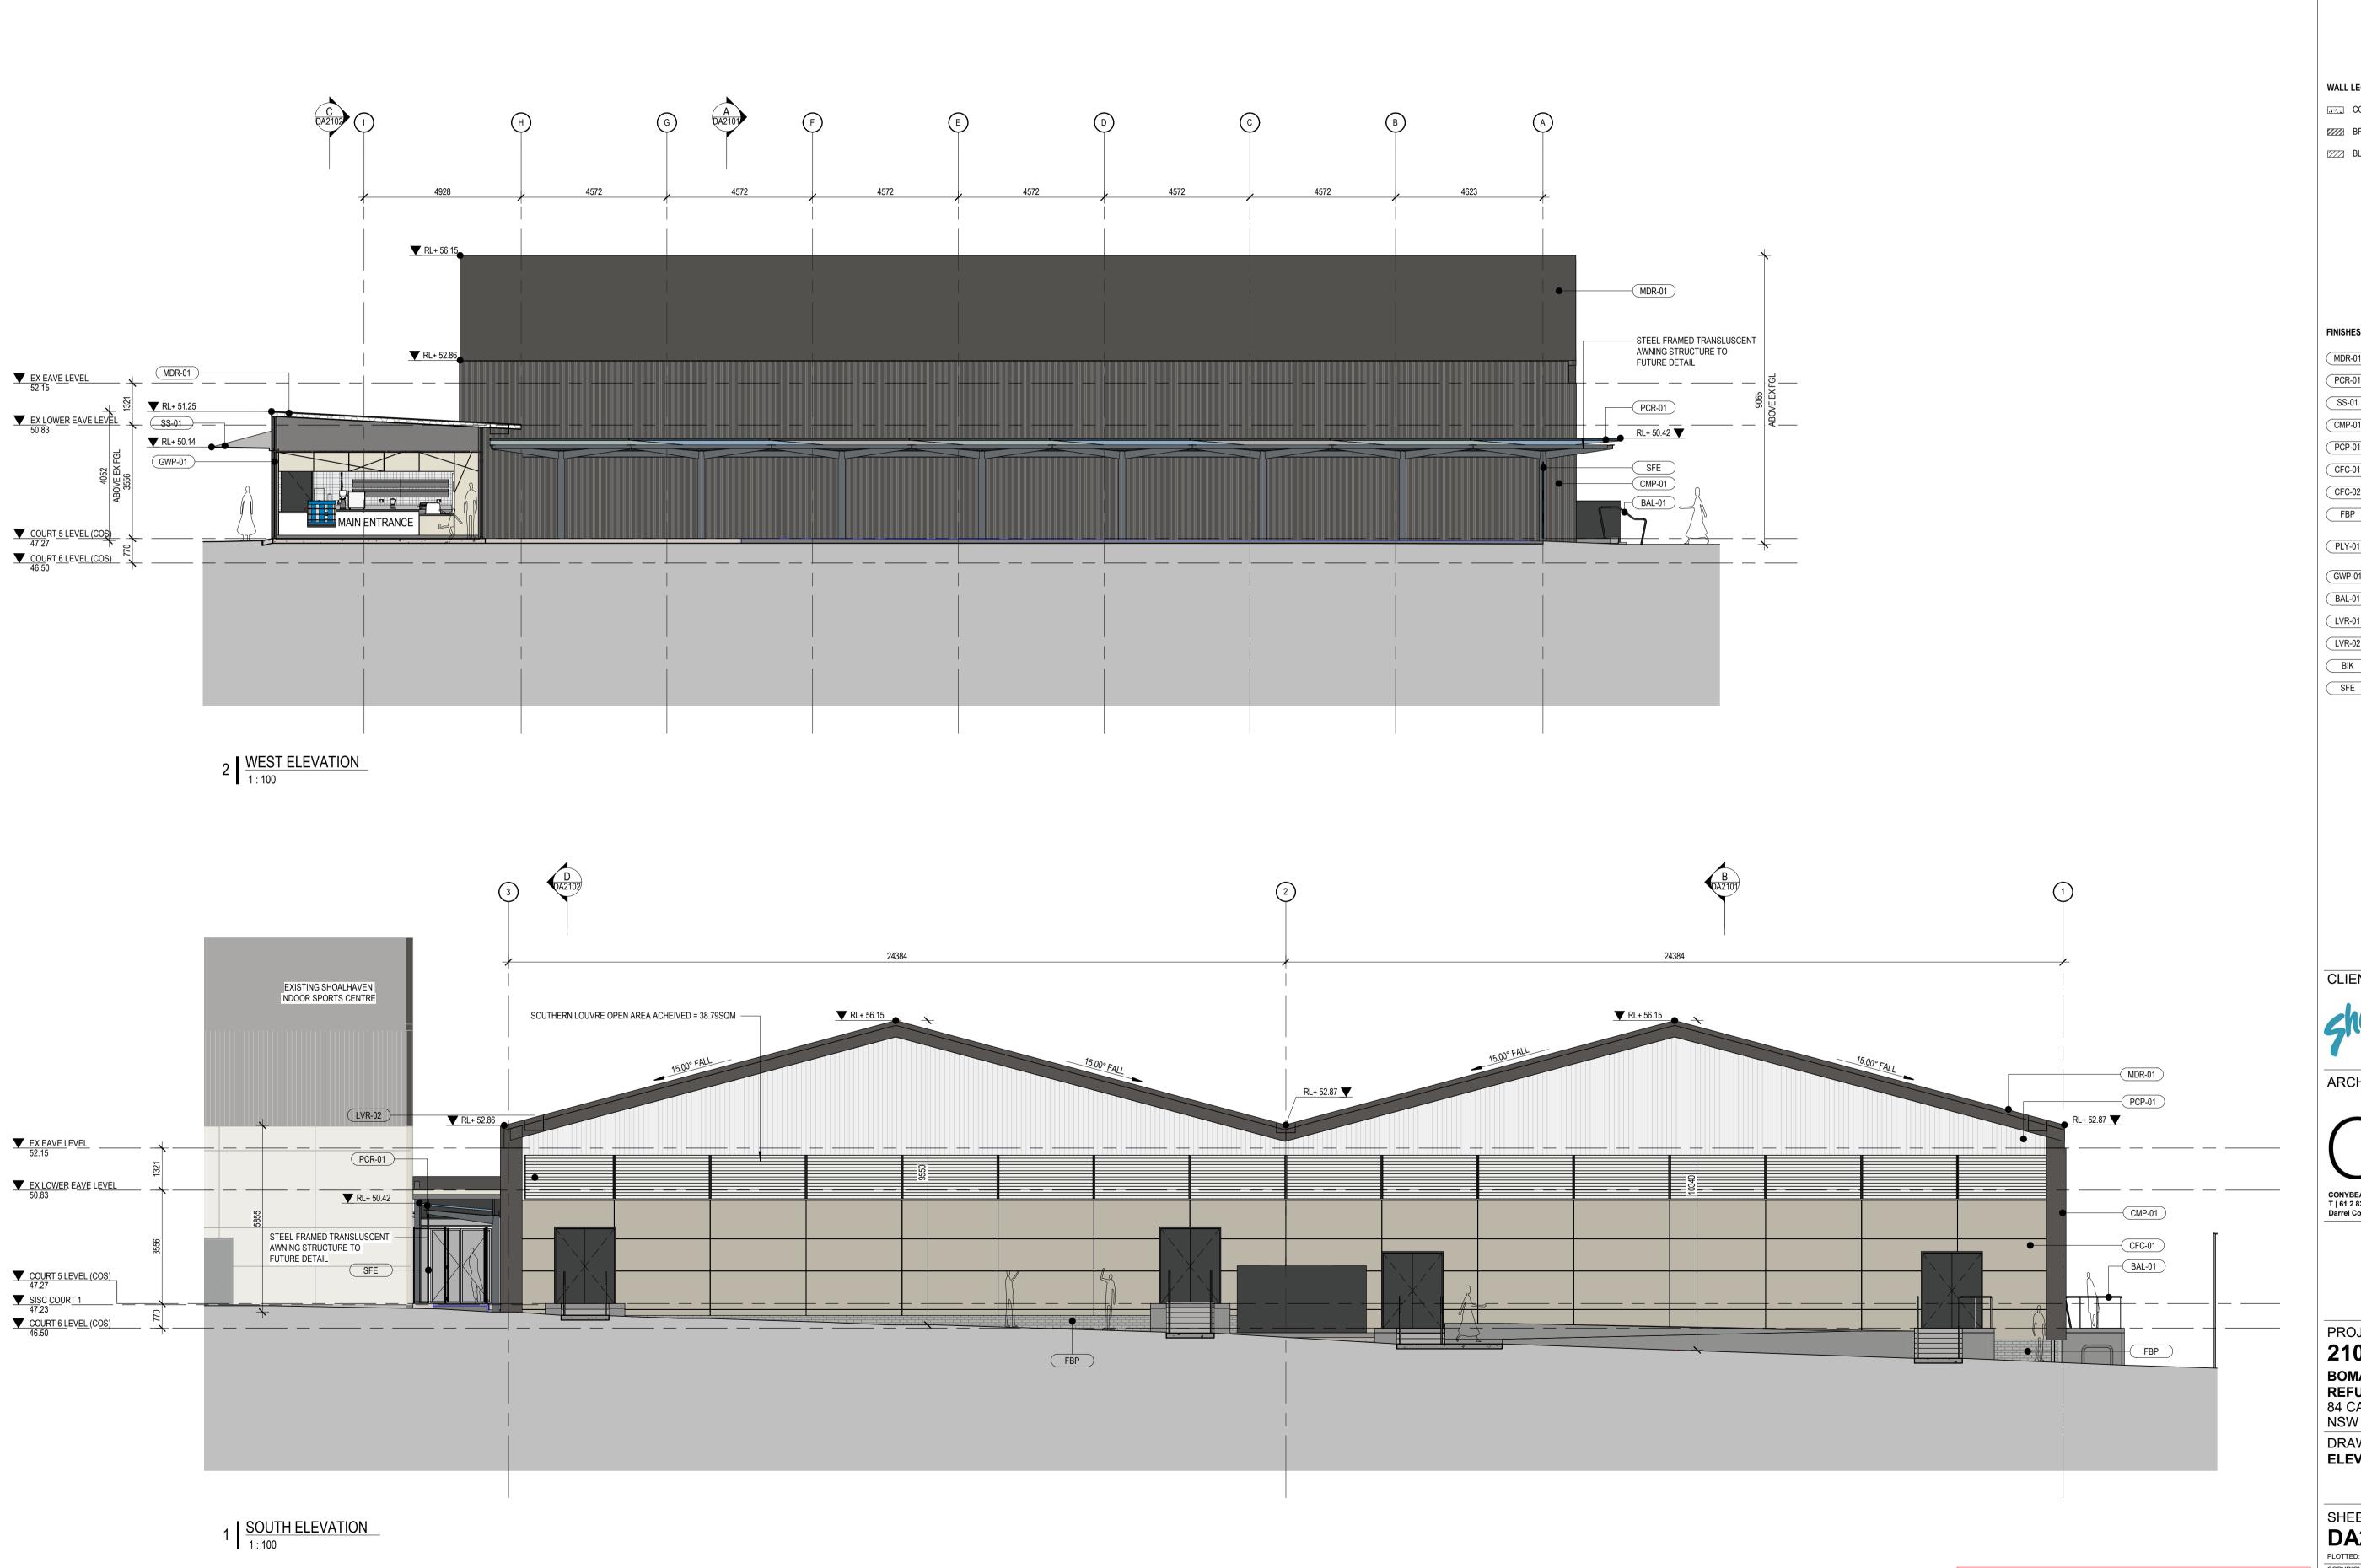
Voctorient Notes

Note Architect Prior to construction. Use figured dimensions in preference to scaled dimensions. Drawings made to larger scales and those showing particular parts of the works take precedence over drawings made to smaller scales or for general purposes. All work is to conform to relevant Australian Standards and Codes









Verify all dimensions on site before commencing work. Report all discrepancies to the Architect Prior to construction. Use figured dimensions in preference to scaled dimensions. Drawings made to larger scales and those showing particular parts of the works take precedence over drawings made to smaller scales or for general purposes. All work is to conform to relevant Australian Standards and Codes together with all Authorities' requirements and Regulations. REV DATE DESCRIPTION
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I 20.07.2022 ISSUE FOR DETAIL DESIGN COORDINATION J 25.07.2022 ISSUE FOR DESIGN COORDINATION K 05.08.2022 ISSUE FOR DA DESIGN COORDINATION L 24.08.2022 ISSUE FOR 95% DESIGN COORDINATION M 12.09.2022 ISSUE FOR DA RFI SUBMISSION WALL LEGEND CONCRETE WORK EXISTING ELEMENT DEMOLISHED ELEMENT BRICKWORK NEW ELEMENT BLOCKWORK TEMPORARY ELEMENT FINISHES SCHEDULE MDR-01 PROFILED METAL ROOFING (WOODLAND GREY) POLYCARBONATE ROOFING (TRANSLUSCENT) SS-01 STAINLESS STEEL PLATE PROFILED METAL WALLING (WOODLAND GREY) POLYCARBONATE WALLING (TRANSLUSCENT) COMPRESSED FIBRE CEMENT CLADDING COMPRESSED FIBRE CEMENT CLADDING REPAIR PAINT APPLICATION TO EXISTING EXTERNAL BRICKWORK BIRCH PLYWOOD PERFORATED WALL ACOUSTIC CLADDING GWP-01 GLAZED WALL PARTITION BAL-01 GALVANISED STEEL BALUSTRADE (BLACK) LVR-01 WEATHERPROOF LOUVRE LVR-02 WEATHERPROOF LOUVRE BIK BICYCLE RACK SFE PALISADE FENCING + GATE CLIENT: ARCHITECT: CONYBEARE MORRISON INTERNATIONAL P\L | ABN 50 055 972 248 T | 61 2 8244 8888 W | www.cmplus.com.au E | mail@cmplus.com.au Darrel Conybeare NSW ARB No 2252 | Bill Morrison NSW ARB No 2447 0 SCALE 1:100 4 SCALE: As indicated @

PROJECT:

21030

BOMADERRY BASKETBALL STADIUM

REFURBISHMENT 84 CAMBEWARRA RD, BOMADERRY, NSW 2541

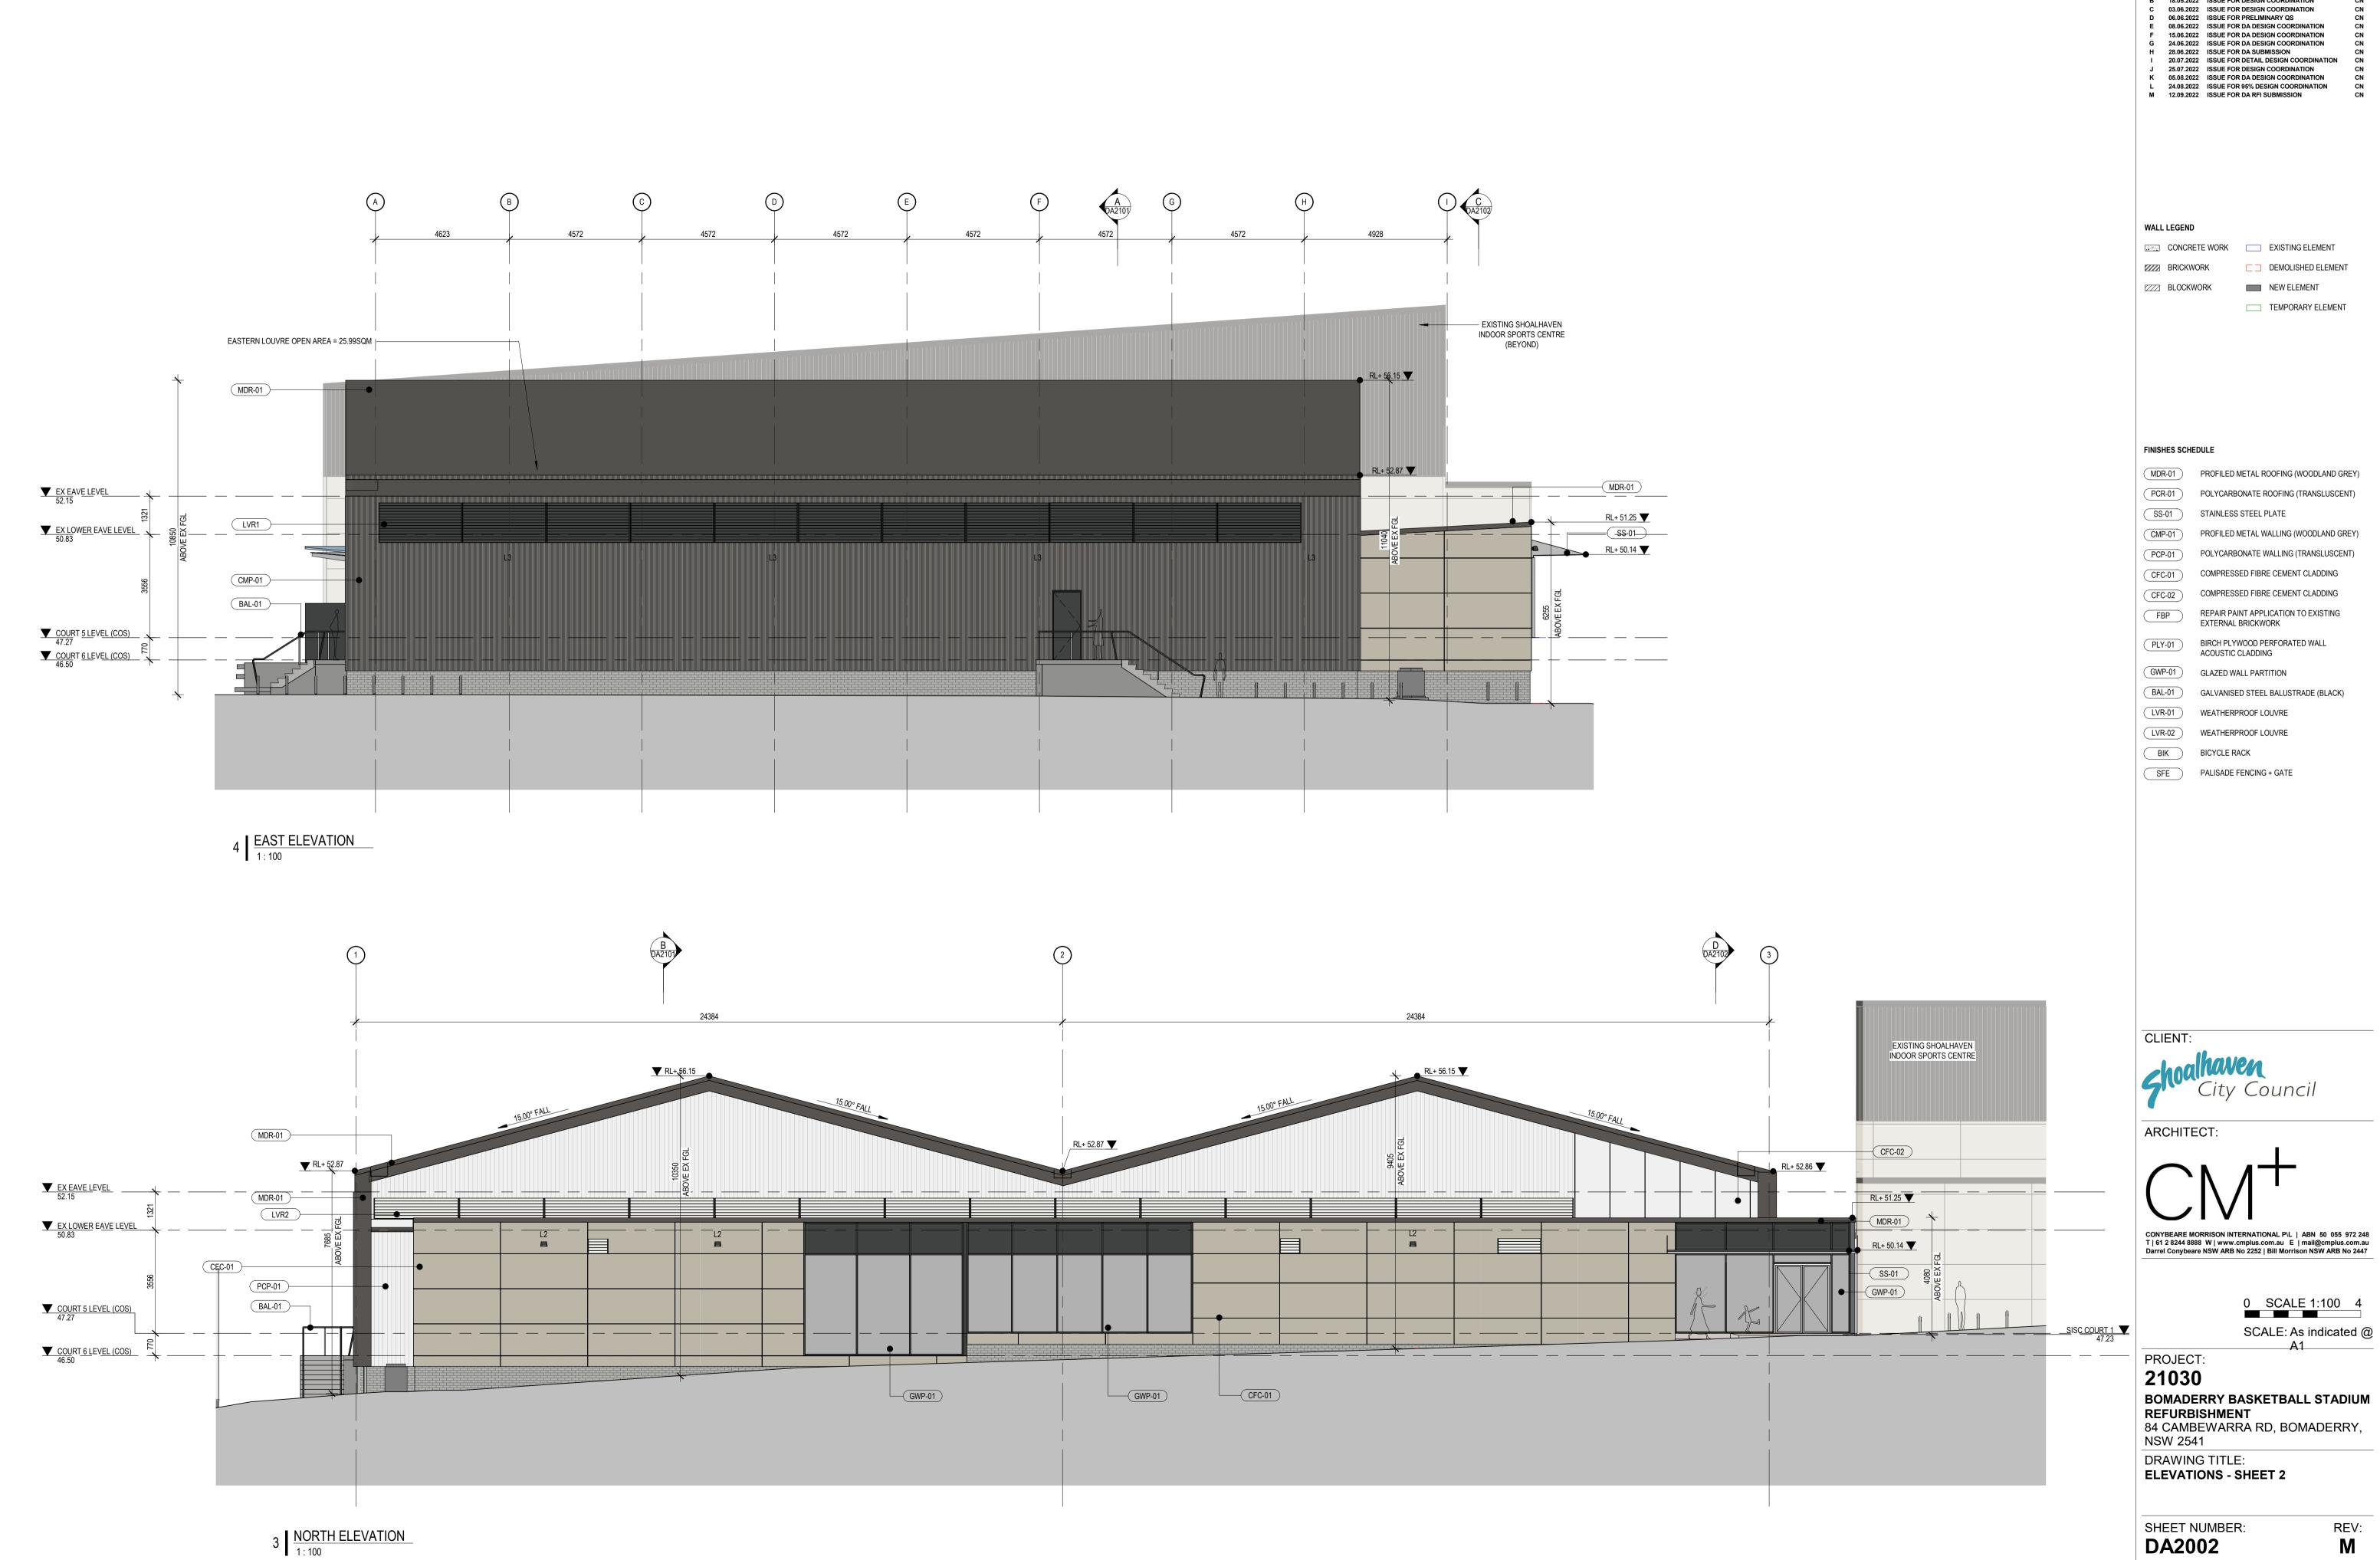
DRAWING TITLE: **ELEVATIONS - SHEET 1** 

SHEET NUMBER: **DA2001** 

M PLOTTED: 12/09/2022 7:31:59 PM

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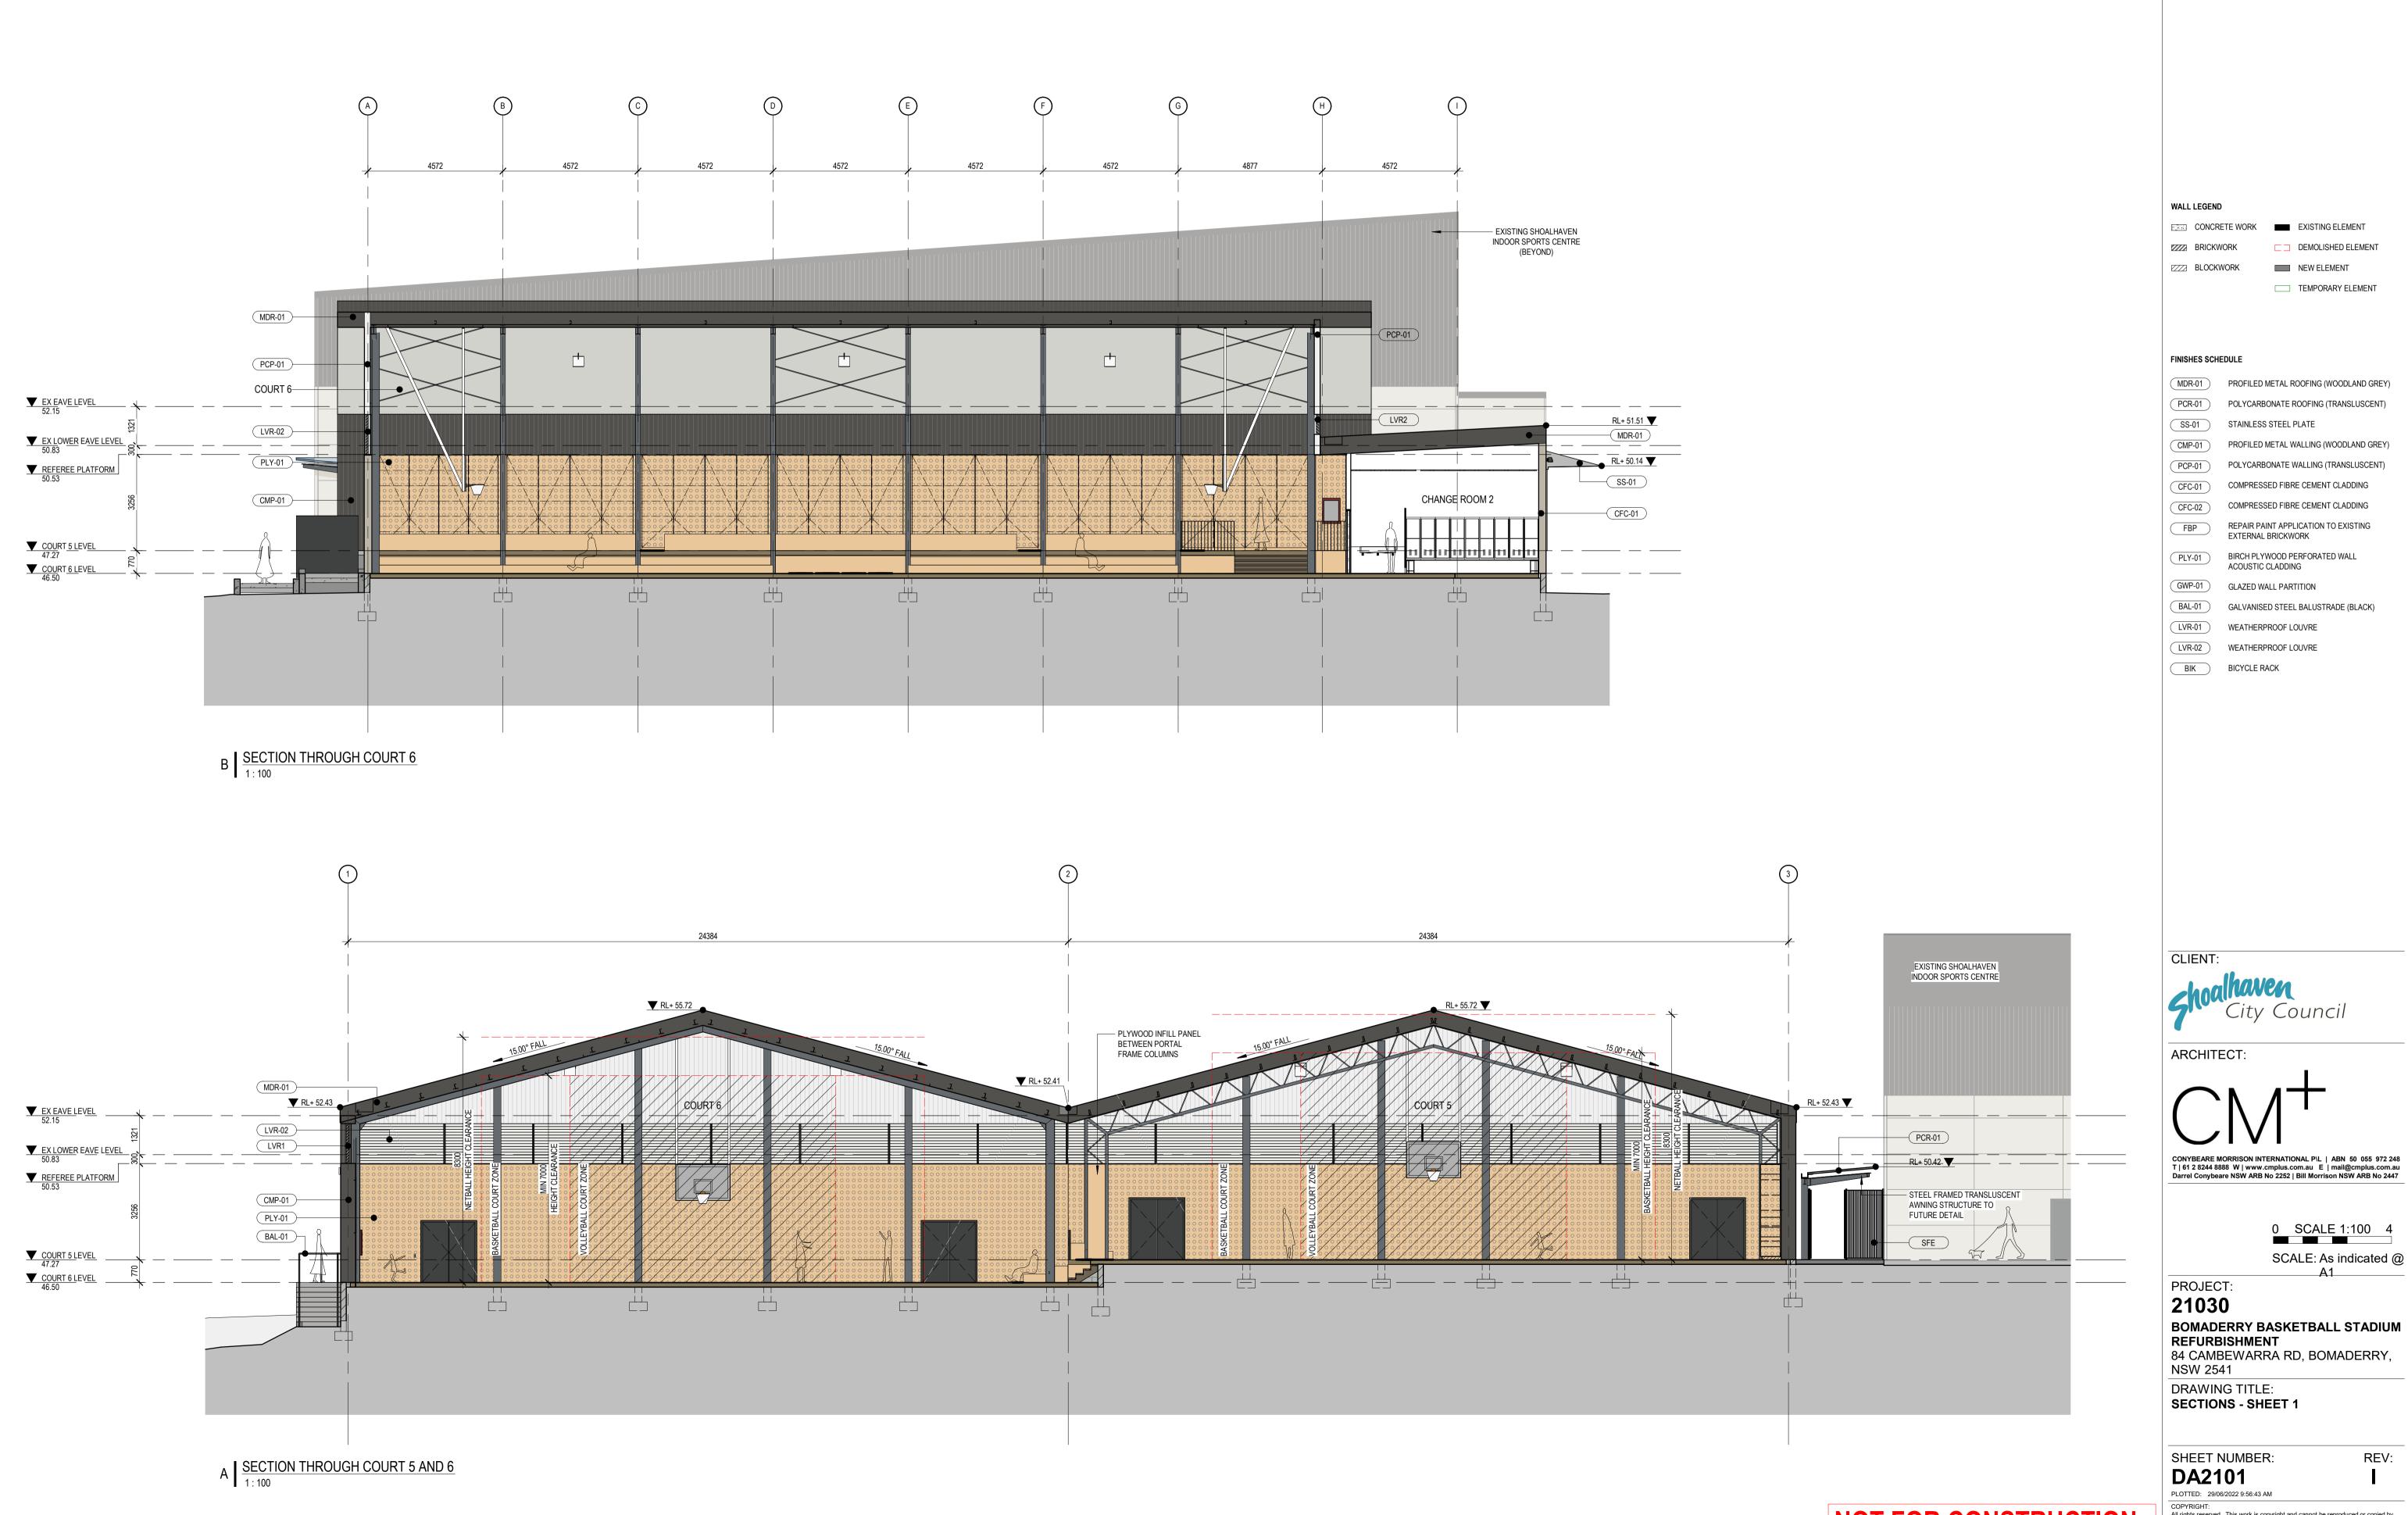


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PLOTTED: 12/09/2022 7:34:02 PM

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CONCRETE WORK EXISTING ELEMENT □ □ DEMOLISHED ELEMENT NEW ELEMENT

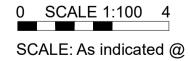
MDR-01 PROFILED METAL ROOFING (WOODLAND GREY) POLYCARBONATE ROOFING (TRANSLUSCENT)

POLYCARBONATE WALLING (TRANSLUSCENT)

COMPRESSED FIBRE CEMENT CLADDING

REPAIR PAINT APPLICATION TO EXISTING

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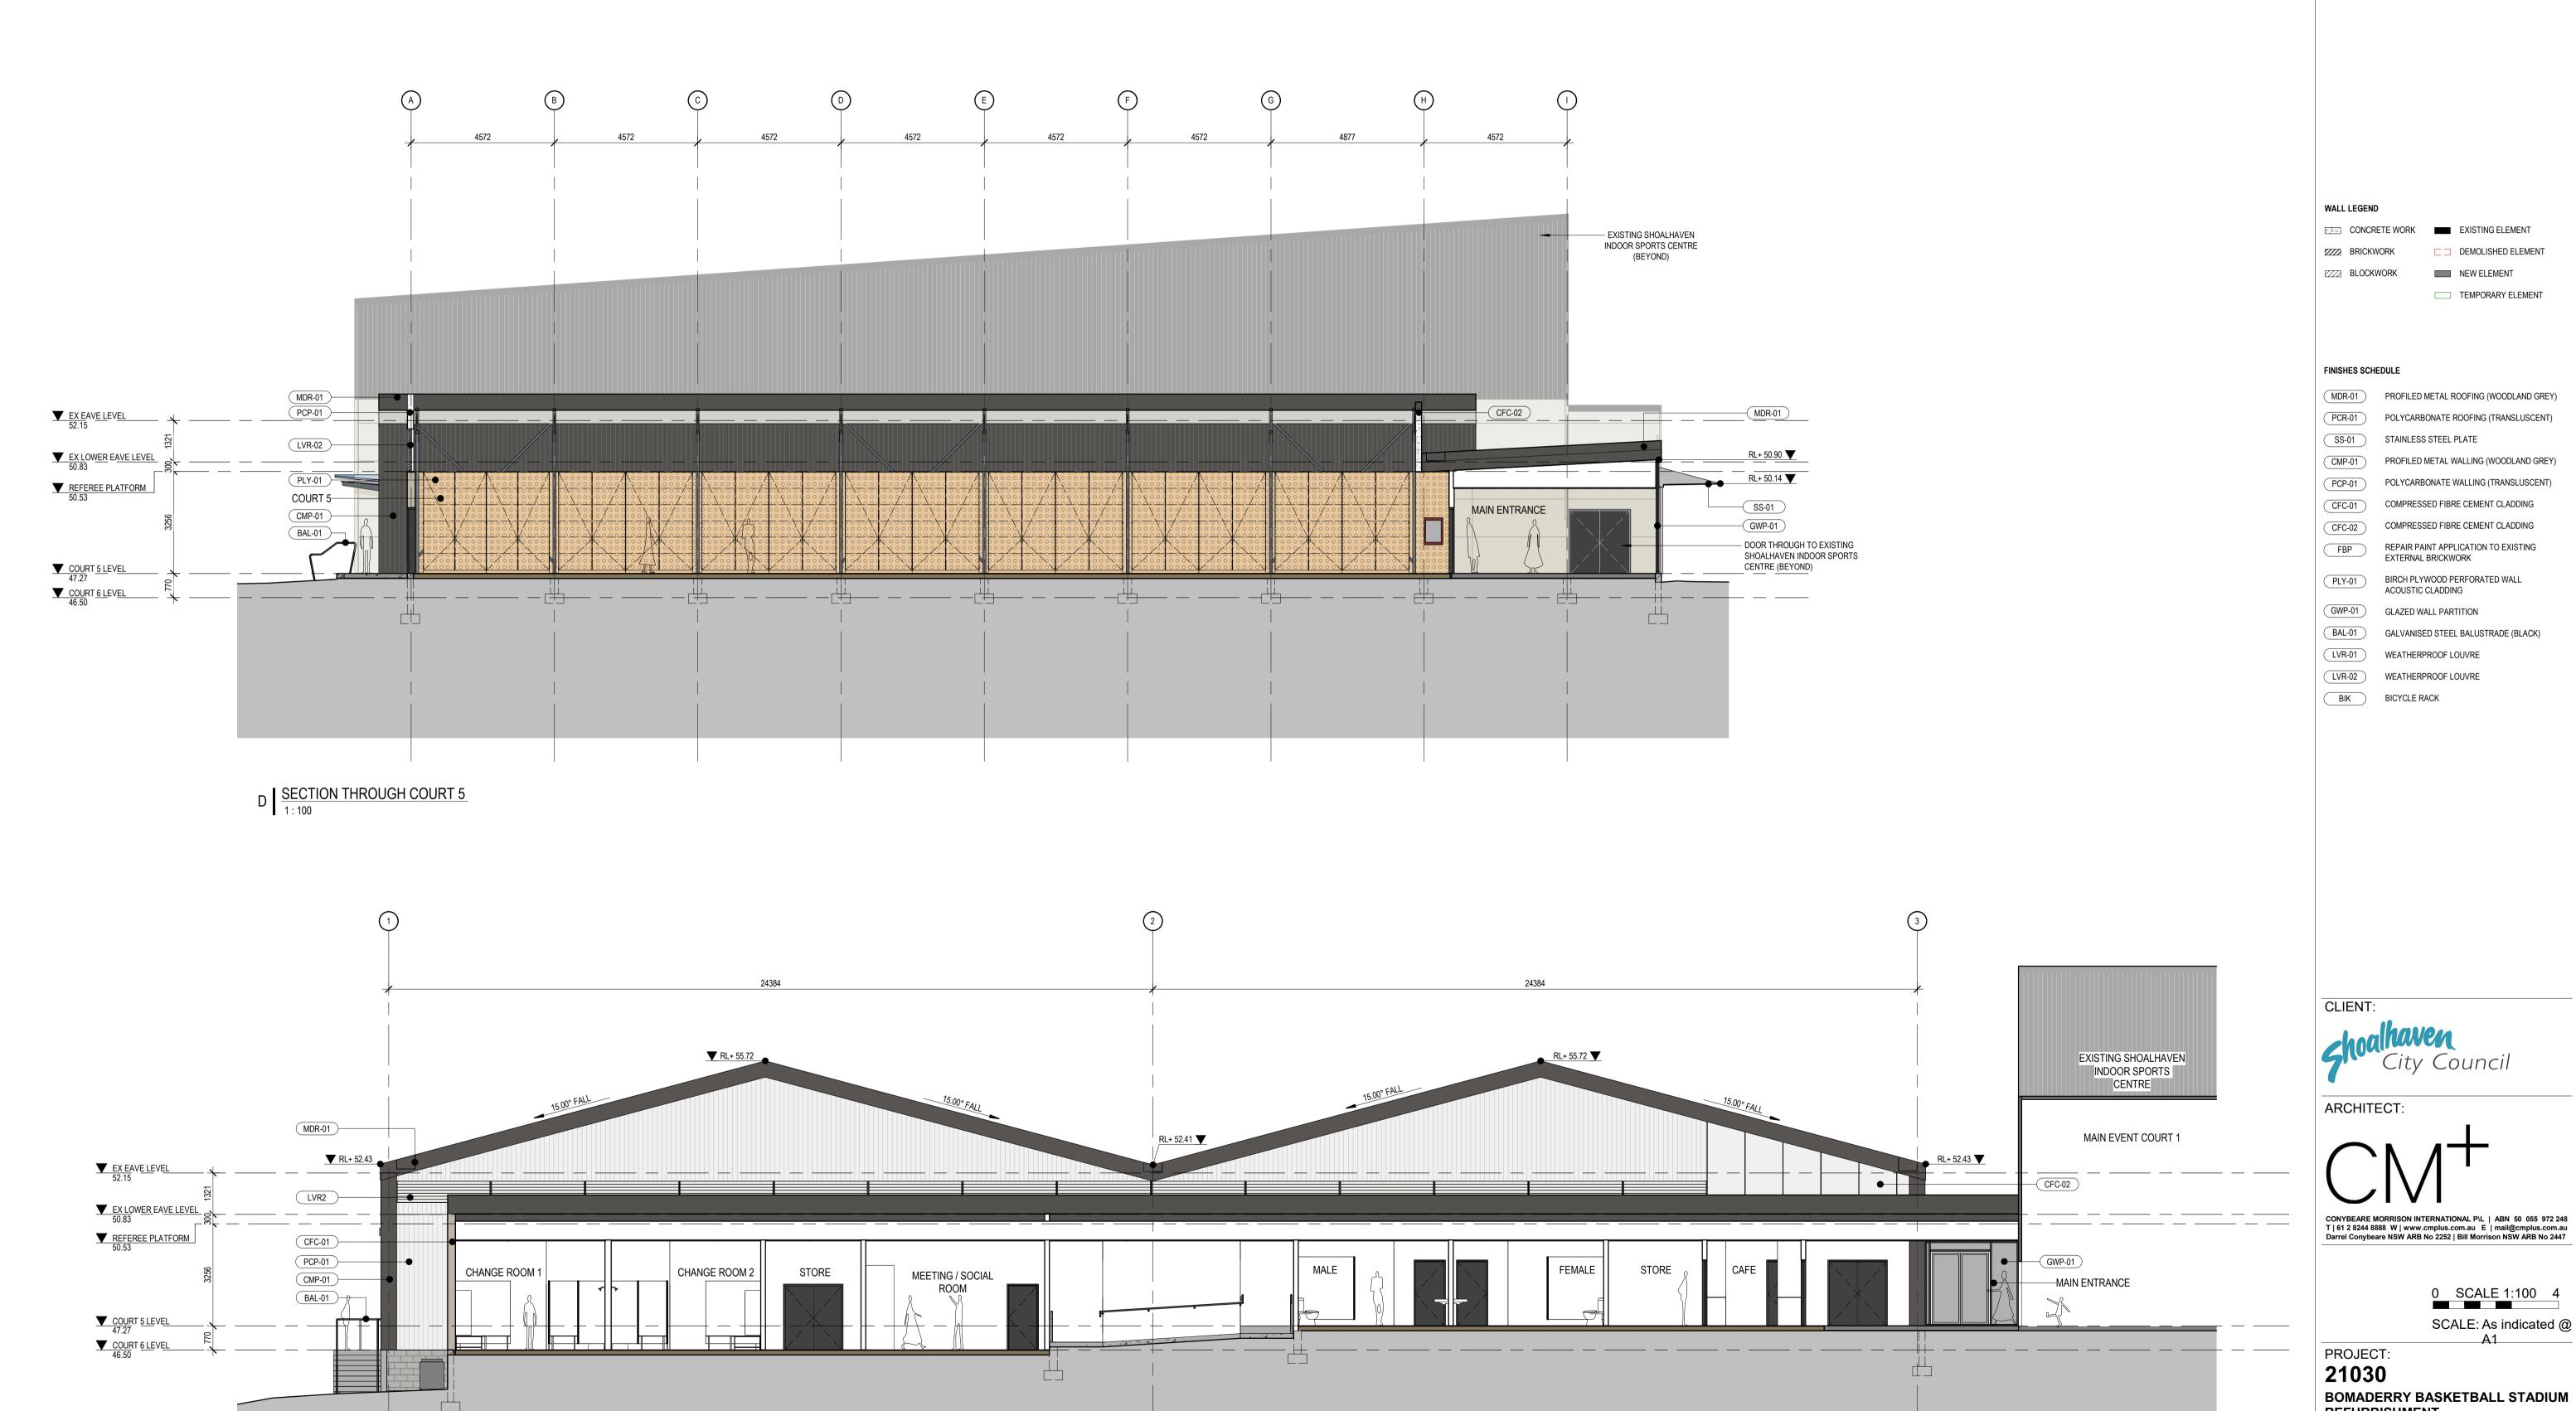


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C SECTION THROUGH AMENITIES
1:100

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 E
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 ISSUE FOR DA SUBMISSION

G 12.09.2022 ISSUE FOR DA RFI SUBMISSION

REFURBISHMENT 84 CAMBEWARRA RD, BOMADERRY, NSW 2541

NSW 2541
DRAWING TITLE:
SECTIONS - SHEET 2

SHEET NUMBER:

**DA2102**PLOTTED: 29/06/2022 9:56:55 AM

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FINISHES SCHEDUL			Tau		I	T	
ELEMENT CODE  EXTERNAL FINISHES	ELEMENT	DESCIPTION	SUPPLIER	MODEL/PRODUCT	FINISH	COLOUR/CODE	IMAGE
WALLS							
CMP-01	WALL CLADDING AND	SELECTION: PROFILE PRE-FINISHED WALL CLADDING. DESCRIPTION: PRE-FINISHED PROFILE CLADDING.		LYSAGHT TRIMDEK PANEL OR APPROVAL	P6 NATURAL (MANUFACTURER COATING SYSTEM)	WOODLAND GREY COLORBOND ULTRA STEEL	
		MATERIAL: COLORBOND ULTRA AM150 FINISH. THICKNESS (BMT): 0.48 mm WITH 29mm RIB DEPTH		EQUIVALENT	,		
		COATING: PROPERITARY POLYESTER PAINT SYSTEM ON BOTH SIDES. SUPPORT AND FIXING: FASTERNING SYSTEM AS PER MANUFACTURER DETAILS.		PROFILE: TRIMDEK			
FBP		SELECTION: REPAIR PAINT APPLICATION TO EXISTING EXTERNAL BRICKWORK.  DESCRIPTION: REFER TO STRUCTURAL SPECIFICATION FOR THE REMOVAL OF EXISTING SALT FINISH AND STRUCTURAL	-	-	JOINT: COVED	DULUX SHALE GREY	Daker Control See Sey *
	SUBFLOOR WALLS WITH	REPAIR. LOW PRESSURE CLEAN WATER WITH BRISTLE BRUSH ONLY, TO REMOVE HARMFUL OR UNSLIGHTLY DEPOSITS OF FOREIGN MATERIALS AND SALTS FROM THE BUILDING FABRIC, WITHOUT DAMAGE TO THE EXISTING BRICKWORK.					
		REFER TO ARCHITECTURAL SPECIFICATION FOR REPOINT AND EPOXY REPAIR AFTER CLEANING. MATERIAL(S): BRICK TILES WITH 10MM MORTAR JOINT TO MATCH EXISTING.					
CFC-01	EXTERNAL WALL	SELECTION: COMPRESSED FIBRE CEMENT FAÇADE PANEL WITH EXPRESSED JOINT SYSTEM.	CEMINTEL	CEMINTEL BARESTONE	SANDED NATURAL FACE WITH		
	CLADDING	EDGES: SQUARE THICKNESS: 9MM	CEMINTEE	WITH THE CEMINTEL EXPRESSWALL SYSTEM	PROPRIETARY PREFINISHED CLEAR COATING		
		TYPICAL PANEL SIZE: 1200H X 2400W JOINT: 10MM EXPOSED JOINT		OR APPROVED EQUIVALENT	TO ALL SIDES		
		FIXING: HORIZONTAL ALIGNED GRID INSTALLATION. SEMI CONCEALED STAINLESS STEEL RIVET STAINLESS STEEL WAFER HEAD SELF SCREW, FINISHED WITH RUSPERT METAL COATING SYSTEM AND COLOUR MATCH WITH PANEL. SIZE OF TOP HATS AND SUPPORTS TO MANUFACTURER DETAILS. PROVIDE CONTINUOUS THERMAL BREAK TAPE IN FRONT OF FRONT					
		FLANGES OF STUDS BEFORE FIXING.					
PCP-01		SELECTION: EXTERNAL POLYCARBONATE MULTICELL PANEL SEAMLESS FACADE SYSTEM. INCLUSION OF ASSOCIATED ALUMINIUM EXTRUDED CONNECTING PROFILES, FRAMING ACCESSORIES AND SEALANTS. PROVIDE CONTINUOUS THERMAL	DANPALON	DANPALON MULTICELL PANELS	FASTENERS & FIXING: CLASS 4 STAINLESS STEEL FINISH		
		BREAK TAPE IN FRONT OF SUBSTRUCTURE BEFORE FIXING.  PANEL JOINT: STANDING SEAM BETWEEN TOP AND BOTTOM FIXINGS.		APPROVED EQUIVALENT	STAINLESS STEEL FINISH		
		PANEL THICKNESS: 16MM (TBC) FIRE PERFORMANCE: AS 5637.1: 2015 GROUP 1					
		U-VALUE: NOT GREATER THAN U2.0					
						Softlite Ice	The state of the s
SFE	GATE TO COORIDOR	SELECTION: PROMAX TRADITIONAL PALISADE FENCE OR EQUAL.  DESCRIPTION: PROPRIETARY STEEL PALISADE FENCE. VETICAL STEEL PALES WITH PENCIL POINTS ATTACHED TO	PROTECTIVE FENCING	FENCE OR APPROVED	PAINT: P5 FINISH: MATT		I W W ALL
		HORIZONTAL STEEL RAILS AND FIXED TO STRUCTURAL GRADE POSTS.  GATE: POWDERCOATED STEEL 3M WIDE HINGED DOUBLE GATE WITH MATCHING VERTICAL STEEL PALES. FINISH GATE TOP WITH BULLDOG SPIKE RAZOR TOPPING (TBC).		EQUIVALENT			
		SIZE: AS PER MANUFACTURER DETAILS.  MATERIAL: HOT-DIP GALVANIZED STEEL WITH POWDER-COAT FINISH.					
		THE WELL HOLD BY GLEVANIZED OLDER WITH ONDER SOMETHING.					
ROOF	+						
MDR-01		SELECTION: PROFILE PREFINISH ALUMINIUM INTEGRATED INSULATED ROOF CLADDING DESCRIPTION: PRE-FINISHED PROFILE ROOF DECKING ON BOTH SIDES WITH INTEGRATED ROOF INSULATION AND SERVICE	ARCPANEL	ECOTEK PANEL OR APPROVAL EQUIVALENT	P6 NATURAL (MANUFACTURER COATING SYSTEM)		
		CORE AT PANEL JOINTS . MATERIAL: COLORBOND ULTRA AM150 FINISH		TOP PROFILE: TRIMDEK	,		
		THICKNESS (BMT): 0.42 mm. COATED: 0.47MM		UNDERSIDE PROFILE: CUSTOM ORB			
		COATING: PROPERITARY POLYESTER PAINT SYSTEM ON EXPOSED SIDE FIRE RATED TO GROUP 1 SUPPORT AND FIXING: FASTERNING SYSTEM AS PER MANUFACTURER DETAILS. INSULATION: EXPANDED POLYSTYRENE WITH FLAME RETARDANT.					
		PANEL THICKNESS: 150mm (TBC), PENDING ON WIND CLASS ROOF INSULATION R3.2 DOWNWARD DIRECTION @ CLIMATE ZONE 6.				Shale Grey™	
		BCA J1.3 (B) SOLAR ABSORPATANCE OF UPPER ROOF SURFACE MUST NOT BE MORE THAN 0.45.				SA = 0.45 BCA = M	•
						PERSONNEL CONTROL CONT	
PCR-01		SELECTION: EXTERNAL POLYCARBONATE MULTICELL PANEL SEAMLESS ROOF SYSTEM. INCLUSION OF ASSOCIATED ALUMINIUM EXTRUDED CONNECTING PROFILES, FRAMING ACCESSORIES AND SEALANTS . PROVIDE CONTINUOUS THERMAL	DANPALON	DANPALON MULTICELL PANELS OR	FASTENERS & FIXING: CLASS 4 STAINLESS STEEL FINISH	ARTIC BLUE GREEN	
		BREAK TAPE IN FRONT OF SUBSTRUCTURE BEFORE FIXING. PANEL JOINT: STANDING SEAM BETWEEN TOP AND BOTTOM FIXINGS. PANEL THICKNESS: 16MM (TBC)		APPROVED EQUIVALENT		GREY	
		FIRE PERFORMANCE: AS 5637.1: 2015 GROUP 1					
							Arctic Blue* Grey
							Arctic Blue* Grey
							Arctic Blue* Grey
							Arctic Blue* Grey
WINDOWS							Arctic Blue* Grey Green
WINDOWS WIN		SELECTION: EXTERNAL COMMERCIAL FLUSH GLAZED FRAMING.	CAPRAL	CAPRAL 425 NARROWLINE	PAINT: P8	AAF EVERSHIELD ANODISED -	
	FLUSH GLAZED FRAMING	DESCRIPTION: PROPRIETARY DOUBLE GLAZED ALUMINIUM ANODISED FIXED PANEL TO SUIT WIND LOAD AS PER STRUCTURAL ENG DETAILS. SPECIFIED PROTECTIVE SECURITY SCREEN BUILD INTO FRAME EXTERNALLY.	CAPRAL	COMMERCIAL FRAME 50 X 100 PROFILE WITH SILICONE SUB	FINISH: MATTE GLAZING: 10.5mm HUSH + 12mm	AAF EVERSHIELD ANODISED - EBONY - Exx-T26M	Green
	FLUSH GLAZED FRAMING	DESCRIPTION: PROPRIETARY DOUBLE GLAZED ALUMINIUM ANODISED FIXED PANEL TO SUIT WIND LOAD AS PER	CAPRAL	COMMERCIAL FRAME 50 X 100	FINISH: MATTE		
	FLUSH GLAZED FRAMING	DESCRIPTION: PROPRIETARY DOUBLE GLAZED ALUMINIUM ANODISED FIXED PANEL TO SUIT WIND LOAD AS PER STRUCTURAL ENG DETAILS. SPECIFIED PROTECTIVE SECURITY SCREEN BUILD INTO FRAME EXTERNALLY. WALL PROFILE: CAPRAL 425 NARROWLINE COMMERCIAL FRAME 50 X 100 PROFILE WITH SILICONE SUB SILL. SIZE: AS PER WINDOW AND GLAZED DOOR SCHEDULE.	CAPRAL	COMMERCIAL FRAME 50 X 100 PROFILE WITH SILICONE SUB	FINISH: MATTE GLAZING: 10.5mm HUSH + 12mm AIR + 6.3mm		Green
	FLUSH GLAZED FRAMING	DESCRIPTION: PROPRIETARY DOUBLE GLAZED ALUMINIUM ANODISED FIXED PANEL TO SUIT WIND LOAD AS PER STRUCTURAL ENG DETAILS. SPECIFIED PROTECTIVE SECURITY SCREEN BUILD INTO FRAME EXTERNALLY.  WALL PROFILE: CAPRAL 425 NARROWLINE COMMERCIAL FRAME 50 X 100 PROFILE WITH SILICONE SUB SILL.  SIZE: AS PER WINDOW AND GLAZED DOOR SCHEDULE.  MATERIAL: ALUMINIUM FRAME IN SELECTED ANODISED FINISH.  ACOUSTIC RATING: RW 41	CAPRAL	COMMERCIAL FRAME 50 X 100 PROFILE WITH SILICONE SUB	FINISH: MATTE GLAZING: 10.5mm HUSH + 12mm AIR + 6.3mm		Green
	FLUSH GLAZED FRAMING	DESCRIPTION: PROPRIETARY DOUBLE GLAZED ALUMINIUM ANODISED FIXED PANEL TO SUIT WIND LOAD AS PER STRUCTURAL ENG DETAILS. SPECIFIED PROTECTIVE SECURITY SCREEN BUILD INTO FRAME EXTERNALLY.  WALL PROFILE: CAPRAL 425 NARROWLINE COMMERCIAL FRAME 50 X 100 PROFILE WITH SILICONE SUB SILL.  SIZE: AS PER WINDOW AND GLAZED DOOR SCHEDULE.  MATERIAL: ALUMINIUM FRAME IN SELECTED ANODISED FINISH.  ACOUSTIC RATING: RW 41	CAPRAL	COMMERCIAL FRAME 50 X 100 PROFILE WITH SILICONE SUB	FINISH: MATTE GLAZING: 10.5mm HUSH + 12mm AIR + 6.3mm		Green
WIN	FLUSH GLAZED FRAMING	DESCRIPTION: PROPRIETARY DOUBLE GLAZED ALUMINIUM ANODISED FIXED PANEL TO SUIT WIND LOAD AS PER STRUCTURAL ENG DETAILS. SPECIFIED PROTECTIVE SECURITY SCREEN BUILD INTO FRAME EXTERNALLY.  WALL PROFILE: CAPRAL 425 NARROWLINE COMMERCIAL FRAME 50 X 100 PROFILE WITH SILICONE SUB SILL.  SIZE: AS PER WINDOW AND GLAZED DOOR SCHEDULE.  MATERIAL: ALUMINIUM FRAME IN SELECTED ANODISED FINISH.  ACOUSTIC RATING: RW 41  ENERGY RATING: MAX U-VALUE 6.7; MAX SHGC VALUES 0.70.	CAPRAL	COMMERCIAL FRAME 50 X 100 PROFILE WITH SILICONE SUB SILL.	FINISH: MATTE GLAZING: 10.5mm HUSH + 12mm AIR + 6.3mm	EBONY - Exx-T26M	Green
	FLUSH GLAZED FRAMING  WEATHERPROOF LOUVRE	DESCRIPTION: PROPRIETARY DOUBLE GLAZED ALUMINIUM ANODISED FIXED PANEL TO SUIT WIND LOAD AS PER STRUCTURAL ENG DETAILS. SPECIFIED PROTECTIVE SECURITY SCREEN BUILD INTO FRAME EXTERNALLY. WALL PROFILE: CAPRAL 425 NARROWLINE COMMERCIAL FRAME 50 X 100 PROFILE WITH SILICONE SUB SILL. SIZE: AS PER WINDOW AND GLAZED DOOR SCHEDULE.  MATERIAL: ALUMINIUM FRAME IN SELECTED ANODISED FINISH. ACOUSTIC RATING: RW 41 ENERGY RATING: MAX U-VALUE 6.7; MAX SHGC VALUES 0.70.  SELECTION: WEATHERPROOF AIR VENTILATION LOUVRE WITH PERFORATED ALUMINIUM MESH. DESCRIPTION: ALUMINIUM FIXED LOUVRE WITH HORIZONTAL CURVED METAL WEATHERPROOF BLADES SET INTO CHANNEL	CAPRAL	COMMERCIAL FRAME 50 X 100 PROFILE WITH SILICONE SUB SILL.  REFERENCE PRODUCT: CONSTRUCTION SPECIALIST	FINISH: MATTE GLAZING: 10.5mm HUSH + 12mm AIR + 6.3mm		Green
WIN	FLUSH GLAZED FRAMING  WEATHERPROOF LOUVRE	DESCRIPTION: PROPRIETARY DOUBLE GLAZED ALUMINIUM ANODISED FIXED PANEL TO SUIT WIND LOAD AS PER STRUCTURAL ENG DETAILS. SPECIFIED PROTECTIVE SECURITY SCREEN BUILD INTO FRAME EXTERNALLY. WALL PROFILE: CAPRAL 425 NARROWLINE COMMERCIAL FRAME 50 X 100 PROFILE WITH SILICONE SUB SILL. SIZE: AS PER WINDOW AND GLAZED DOOR SCHEDULE. MATERIAL: ALUMINIUM FRAME IN SELECTED ANODISED FINISH. ACOUSTIC RATING: RW 41 ENERGY RATING: MAX U-VALUE 6.7; MAX SHGC VALUES 0.70.		COMMERCIAL FRAME 50 X 100 PROFILE WITH SILICONE SUB SILL.  REFERENCE PRODUCT:	FINISH: MATTE GLAZING: 10.5mm HUSH + 12mm AIR + 6.3mm LAMINATED GLAZING  FINISH: P8 ANODISED	AAF EVERSHIELD ANODISED -	Green
WIN	FLUSH GLAZED FRAMING  WEATHERPROOF LOUVRE	DESCRIPTION: PROPRIETARY DOUBLE GLAZED ALUMINIUM ANODISED FIXED PANEL TO SUIT WIND LOAD AS PER STRUCTURAL ENG DETAILS. SPECIFIED PROTECTIVE SECURITY SCREEN BUILD INTO FRAME EXTERNALLY. WALL PROFILE: CAPRAL 425 NARROWLINE COMMERCIAL FRAME 50 X 100 PROFILE WITH SILICONE SUB SILL. SIZE: AS PER WINDOW AND GLAZED DOOR SCHEDULE.  MATERIAL: ALUMINIUM FRAME IN SELECTED ANODISED FINISH. ACOUSTIC RATING: RW 41  ENERGY RATING: MAX U-VALUE 6.7; MAX SHGC VALUES 0.70.  SELECTION: WEATHERPROOF AIR VENTILATION LOUVRE WITH PERFORATED ALUMINIUM MESH. DESCRIPTION: ALUMINIUM FIXED LOUVRE WITH HORIZONTAL CURVED METAL WEATHERPROOF BLADES SET INTO CHANNEL SECTION FRAMES WITH INSECT MESH AND FIXED INTO OPENINGS.		COMMERCIAL FRAME 50 X 100 PROFILE WITH SILICONE SUB SILL.  REFERENCE PRODUCT: CONSTRUCTION SPECIALIST	FINISH: MATTE GLAZING: 10.5mm HUSH + 12mm AIR + 6.3mm LAMINATED GLAZING  FINISH: P8 ANODISED	AAF EVERSHIELD ANODISED -	Green  EBONY   EXXT26M
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LVR-01	FLUSH GLAZED FRAMING WEATHERPROOF LOUVRE	DESCRIPTION: PROPRIETARY DOUBLE GLAZED ALUMINIUM ANODISED FIXED PANEL TO SUIT WIND LOAD AS PER STRUCTURAL ENG DETAILS. SPECIFIED PROTECTIVE SECURITY SCREEN BUILD INTO FRAME EXTERNALLY. WALL PROFILE: CAPRAL 425 NARROWLINE COMMERCIAL FRAME 50 X 100 PROFILE WITH SILICONE SUB SILL. SIZE: AS PER WINDOW AND GLAZED DOOR SCHEDULE. MATERIAL: ALUMINIUM FRAME IN SELECTED ANODISED FINISH. ACOUSTIC RATING: RW 41 ENERGY RATING: MAX U-VALUE 6.7; MAX SHGC VALUES 0.70.  SELECTION: WEATHERPROOF AIR VENTILATION LOUVRE WITH PERFORATED ALUMINIUM MESH. DESCRIPTION: ALUMINIUM FIXED LOUVRE WITH HORIZONTAL CURVED METAL WEATHERPROOF BLADES SET INTO CHANNEL SECTION FRAMES WITH INSECT MESH AND FIXED INTO OPENINGS. FREE AREA: TO MECHANICAL ENGINEER SPECIFICATION	TBC	COMMERCIAL FRAME 50 X 100 PROFILE WITH SILICONE SUB SILL.  REFERENCE PRODUCT: CONSTRUCTION SPECIALIST PERFORM LOUVERS	FINISH: MATTE GLAZING: 10.5mm HUSH + 12mm AIR + 6.3mm LAMINATED GLAZING  FINISH: P8 ANODISED FINISH: MATT	AAF EVERSHIELD ANODISED - EBONY - Exx-T26M	Green  EBONY   EXXT26M
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LVR-01	WEATHERPROOF LOUVRE  WEATHERPROOF LOUVRE	DESCRIPTION: PROPRIETARY DOUBLE GLAZED ALUMINIUM ANODISED FIXED PANEL TO SUIT WIND LOAD AS PER STRUCTURAL ENG DETAILS. SPECIFIED PROTECTIVE SECURITY SCREEN BUILD INTO FRAME EXTERNALLY. WALL PROFILE: CAPRAL 425 NARROWLINE COMMERCIAL FRAME 50 X 100 PROFILE WITH SILICONE SUB SILL. SIZE: AS PER WINDOW AND GLAZED DOOR SCHEDULE. MATERIAL: ALUMINIUM FRAME IN SELECTED ANODISED FINISH. ACOUSTIC RATING: RW 41 ENERGY RATING: MAX U-VALUE 6.7; MAX SHGC VALUES 0.70.  SELECTION: WEATHERPROOF AIR VENTILATION LOUVRE WITH PERFORATED ALUMINIUM MESH. DESCRIPTION: ALUMINIUM FIXED LOUVRE WITH HORIZONTAL CURVED METAL WEATHERPROOF BLADES SET INTO CHANNEL SECTION FRAMES WITH INSECT MESH AND FIXED INTO OPENINGS. FREE AREA: TO MECHANICAL ENGINEER SPECIFICATION  SELECTION: WEATHERPROOF AIR VENTILATION LOUVRE  SELECTION: WEATHERPROOF AIR VENTILATION LOUVRE  DESCRIPTION: GLASS FIXED LOUVRE WITH HORIZONTAL CURVED METAL WEATHERPROOF BLADES SET INTO CHANNEL  SELECTION: WEATHERPROOF AIR VENTILATION LOUVRE  DESCRIPTION: GLASS FIXED LOUVRE WITH HORIZONTAL CURVED METAL WEATHERPROOF BLADES SET INTO CHANNEL	TBC	COMMERCIAL FRAME 50 X 100 PROFILE WITH SILICONE SUB SILL.  REFERENCE PRODUCT: CONSTRUCTION SPECIALIST PERFORM LOUVERS	FINISH: MATTE GLAZING: 10.5mm HUSH + 12mm AIR + 6.3mm LAMINATED GLAZING  FINISH: P8 ANODISED FINISH: MATT	AAF EVERSHIELD ANODISED - EBONY - Exx-T26M  COLOUR: DULUX FLUOROSET POWDER COATED - XTREME	Green  EBONY   EXXT26M
LVR-01	WEATHERPROOF LOUVRE  WEATHERPROOF LOUVRE	DESCRIPTION: PROPRIETARY DOUBLE GLAZED ALUMINIUM ANODISED FIXED PANEL TO SUIT WIND LOAD AS PER STRUCTURAL ENG DETAILS. SPECIFIED PROTECTIVE SECURITY SCREEN BUILD INTO FRAME EXTERNALLY.  WALL PROFILE: CAPRAL 425 NARROWLINE COMMERCIAL FRAME 50 X 100 PROFILE WITH SILICONE SUB SILL.  SIZE: AS PER WINDOW AND GLAZED DOOR SCHEDULE.  MATERIAL: ALUMINIUM FRAME IN SELECTED ANODISED FINISH.  ACOUSTIC RATING: RW 41  ENERGY RATING: MAX U-VALUE 6.7; MAX SHGC VALUES 0.70.  SELECTION: WEATHERPROOF AIR VENTILATION LOUVRE WITH PERFORATED ALUMINIUM MESH.  DESCRIPTION: ALUMINIUM FIXED LOUVRE WITH HORIZONTAL CURVED METAL WEATHERPROOF BLADES SET INTO CHANNEL SECTION FRAMES WITH INSECT MESH AND FIXED INTO OPENINGS.  FREE AREA: TO MECHANICAL ENGINEER SPECIFICATION  SELECTION: WEATHERPROOF AIR VENTILATION LOUVRE  DESCRIPTION: GLASS FIXED LOUVRE WITH HORIZONTAL CURVED METAL WEATHERPROOF BLADES SET INTO CHANNEL SECTION FRAMES WITH HORIZONTAL CURVED METAL WEATHERPROOF BLADES SET INTO CHANNEL SECTION FRAMES WITH HORIZONTAL CURVED METAL WEATHERPROOF BLADES SET INTO CHANNEL SECTION FRAMES WITH INSECT MESH AND FIXED INTO OPENINGS	TBC	COMMERCIAL FRAME 50 X 100 PROFILE WITH SILICONE SUB SILL.  REFERENCE PRODUCT: CONSTRUCTION SPECIALIST PERFORM LOUVERS	FINISH: MATTE GLAZING: 10.5mm HUSH + 12mm AIR + 6.3mm LAMINATED GLAZING  FINISH: P8 ANODISED FINISH: MATT	AAF EVERSHIELD ANODISED - EBONY - Exx-T26M  COLOUR: DULUX FLUOROSET POWDER COATED - XTREME	Green  EBONY   EXXYZEM  EBONY   EXXYZEM  AND THE STATE OF
LVR-01	WEATHERPROOF LOUVRE  WEATHERPROOF LOUVRE	DESCRIPTION: PROPRIETARY DOUBLE GLAZED ALUMINIUM ANODISED FIXED PANEL TO SUIT WIND LOAD AS PER STRUCTURAL ENG DETAILS. SPECIFIED PROTECTIVE SECURITY SCREEN BUILD INTO FRAME EXTERNALLY.  WALL PROFILE: CAPRAL 425 NARROWLINE COMMERCIAL FRAME 50 X 100 PROFILE WITH SILICONE SUB SILL.  SIZE: AS PER WINDOW AND GLAZED DOOR SCHEDULE.  MATERIAL: ALUMINIUM FRAME IN SELECTED ANODISED FINISH.  ACOUSTIC RATING: RW 41  ENERGY RATING: MAX U-VALUE 6.7; MAX SHGC VALUES 0.70.  SELECTION: WEATHERPROOF AIR VENTILATION LOUVRE WITH PERFORATED ALUMINIUM MESH.  DESCRIPTION: ALUMINIUM FIXED LOUVRE WITH HORIZONTAL CURVED METAL WEATHERPROOF BLADES SET INTO CHANNEL SECTION FRAMES WITH INSECT MESH AND FIXED INTO OPENINGS.  FREE AREA: TO MECHANICAL ENGINEER SPECIFICATION  SELECTION: WEATHERPROOF AIR VENTILATION LOUVRE  DESCRIPTION: GLASS FIXED LOUVRE WITH HORIZONTAL CURVED METAL WEATHERPROOF BLADES SET INTO CHANNEL SECTION FRAMES WITH HORIZONTAL CURVED METAL WEATHERPROOF BLADES SET INTO CHANNEL SECTION FRAMES WITH HORIZONTAL CURVED METAL WEATHERPROOF BLADES SET INTO CHANNEL SECTION FRAMES WITH INSECT MESH AND FIXED INTO OPENINGS	TBC	COMMERCIAL FRAME 50 X 100 PROFILE WITH SILICONE SUB SILL.  REFERENCE PRODUCT: CONSTRUCTION SPECIALIST PERFORM LOUVERS	FINISH: MATTE GLAZING: 10.5mm HUSH + 12mm AIR + 6.3mm LAMINATED GLAZING  FINISH: P8 ANODISED FINISH: MATT	AAF EVERSHIELD ANODISED - EBONY - Exx-T26M  COLOUR: DULUX FLUOROSET POWDER COATED - XTREME	Green  EBONY   EXXYZEM  EBONY   EXXYZEM  AND THE STATE OF
LVR-01	WEATHERPROOF LOUVRE  WEATHERPROOF LOUVRE	DESCRIPTION: PROPRIETARY DOUBLE GLAZED ALUMINIUM ANODISED FIXED PANEL TO SUIT WIND LOAD AS PER STRUCTURAL ENG DETAILS. SPECIFIED PROTECTIVE SECURITY SCREEN BUILD INTO FRAME EXTERNALLY.  WALL PROFILE: CAPRAL 425 NARROWLINE COMMERCIAL FRAME 50 X 100 PROFILE WITH SILICONE SUB SILL.  SIZE: AS PER WINDOW AND GLAZED DOOR SCHEDULE.  MATERIAL: ALUMINIUM FRAME IN SELECTED ANODISED FINISH.  ACOUSTIC RATING: RW 41  ENERGY RATING: MAX U-VALUE 6.7; MAX SHGC VALUES 0.70.  SELECTION: WEATHERPROOF AIR VENTILATION LOUVRE WITH PERFORATED ALUMINIUM MESH.  DESCRIPTION: ALUMINIUM FIXED LOUVRE WITH HORIZONTAL CURVED METAL WEATHERPROOF BLADES SET INTO CHANNEL SECTION FRAMES WITH INSECT MESH AND FIXED INTO OPENINGS.  FREE AREA: TO MECHANICAL ENGINEER SPECIFICATION  SELECTION: WEATHERPROOF AIR VENTILATION LOUVRE  DESCRIPTION: GLASS FIXED LOUVRE WITH HORIZONTAL CURVED METAL WEATHERPROOF BLADES SET INTO CHANNEL SECTION FRAMES WITH HORIZONTAL CURVED METAL WEATHERPROOF BLADES SET INTO CHANNEL SECTION FRAMES WITH HORIZONTAL CURVED METAL WEATHERPROOF BLADES SET INTO CHANNEL SECTION FRAMES WITH INSECT MESH AND FIXED INTO OPENINGS	TBC	COMMERCIAL FRAME 50 X 100 PROFILE WITH SILICONE SUB SILL.  REFERENCE PRODUCT: CONSTRUCTION SPECIALIST PERFORM LOUVERS	FINISH: MATTE GLAZING: 10.5mm HUSH + 12mm AIR + 6.3mm LAMINATED GLAZING  FINISH: P8 ANODISED FINISH: MATT	AAF EVERSHIELD ANODISED - EBONY - Exx-T26M  COLOUR: DULUX FLUOROSET POWDER COATED - XTREME	Green  EBONY   EXXYZEM  EBONY   EXXYZEM  AND THE STATE OF
LVR-01	WEATHERPROOF LOUVRE  WEATHERPROOF LOUVRE	DESCRIPTION: PROPRIETARY DOUBLE GLAZED ALUMINIUM ANODISED FIXED PANEL TO SUIT WIND LOAD AS PER STRUCTURAL ENG DETAILS. SPECIFIED PROTECTIVE SECURITY SCREEN BUILD INTO FRAME EXTERNALLY.  WALL PROFILE: CAPRAL 425 NARROWLINE COMMERCIAL FRAME 50 X 100 PROFILE WITH SILICONE SUB SILL.  SIZE: AS PER WINDOW AND GLAZED DOOR SCHEDULE.  MATERIAL: ALUMINIUM FRAME IN SELECTED ANODISED FINISH.  ACOUSTIC RATING: RW 41  ENERGY RATING: MAX U-VALUE 6.7; MAX SHGC VALUES 0.70.  SELECTION: WEATHERPROOF AIR VENTILATION LOUVRE WITH PERFORATED ALUMINIUM MESH.  DESCRIPTION: ALUMINIUM FIXED LOUVRE WITH HORIZONTAL CURVED METAL WEATHERPROOF BLADES SET INTO CHANNEL SECTION FRAMES WITH INSECT MESH AND FIXED INTO OPENINGS.  FREE AREA: TO MECHANICAL ENGINEER SPECIFICATION  SELECTION: WEATHERPROOF AIR VENTILATION LOUVRE  DESCRIPTION: GLASS FIXED LOUVRE WITH HORIZONTAL CURVED METAL WEATHERPROOF BLADES SET INTO CHANNEL SECTION FRAMES WITH HORIZONTAL CURVED METAL WEATHERPROOF BLADES SET INTO CHANNEL SECTION FRAMES WITH HORIZONTAL CURVED METAL WEATHERPROOF BLADES SET INTO CHANNEL SECTION FRAMES WITH INSECT MESH AND FIXED INTO OPENINGS	TBC	COMMERCIAL FRAME 50 X 100 PROFILE WITH SILICONE SUB SILL.  REFERENCE PRODUCT: CONSTRUCTION SPECIALIST PERFORM LOUVERS	FINISH: MATTE GLAZING: 10.5mm HUSH + 12mm AIR + 6.3mm LAMINATED GLAZING  FINISH: P8 ANODISED FINISH: MATT	AAF EVERSHIELD ANODISED - EBONY - Exx-T26M  COLOUR: DULUX FLUOROSET POWDER COATED - XTREME	Green  EBONY   EXXYZEM  EBONY   EXXYZEM  AND THE STATE OF
LVR-01  LVR-02  DOORS	WEATHERPROOF LOUVRE  WEATHERPROOF LOUVRE	DESCRIPTION: PROPRIETARY DOUBLE GLAZED ALUMINIUM ANDOISED FIXED PANEL TO SUIT WIND LOAD AS PER STRUCTURAL ENG DETAILS. SPECIFIED PROTECTIVE SECURITY SCREEN BUILD INTO FRAME EXTERNALLY. WALL PROFILE: CAPRAL 42S NARROWLINE COMMERCIAL FRAME 50 X 100 PROFILE WITH SILICONE SUB SILL. SIZE: AS PER WINDOW AND GLAZED DOOR SCHEDULE. MATERIAL: ALUMINIUM FRAME IN SELECTED ANDDISED FINISH. ACOUSTIC RATING: RW 41 ENERGY RATING: RW 41 ENERGY RATING: MAX U-VALUE 6.7; MAX SHGC VALUES 0.70.  SELECTION: WEATHERPROOF AIR VENTILATION LOUVRE WITH PERFORATED ALUMINIUM MESH. DESCRIPTION: ALUMINIUM FIXED LOUVRE WITH HORIZONTAL CURVED METAL WEATHERPROOF BLADES SET INTO CHANNEL SECTION FRAMES WITH INSECT MESH AND FIXED INTO OPENINGS. FREE AREA: TO MECHANICAL ENGINEER SPECIFICATION  SELECTION: WEATHERPROOF AIR VENTILATION LOUVRE DESCRIPTION: GLASS FIXED LOUVRE WITH HORIZONTAL CURVED METAL WEATHERPROOF BLADES SET INTO CHANNEL BESCHION FRAMES WITH INSECT MESH AND FIXED INTO OPENINGS FREE AREA: TO MECHANICAL ENGINEER SPECIFICATION	TBC	COMMERCIAL FRAME 50 X 100 PROFILE WITH SILICONE SUB SILL.  REFERENCE PRODUCT: CONSTRUCTION SPECIALIST PERFORM LOUVERS  TBC	FINISH: MATTE GLAZING: 10.5mm HUSH + 12mm AIR + 6.3mm LAMINATED GLAZING  FINISH: P8 ANODISED FINISH: MATT  FINISH: P7 POWDER COAT FINISH: MATT	AAF EVERSHIELD ANODISED - EBONY - Exx-T26M  COLOUR: DULUX FLUOROSET POWDER COATED - XTREME	Green  EBONY   EXXYZEM  EBONY   EXXYZEM  AND THE STATE OF
LVR-01	WEATHERPROOF LOUVRE  WEATHERPROOF LOUVRE  COMMERCIAL FLUSH EXTERNAL GLAZED	I DESCRIPTION PROPRIETARY DOUBLE GLAZED ALUMINIUM ANODISED FIXED PANEL TO SUIT WIND LOAD AS PER STRUCTURAL HENG DETAILS. SPECIFIED PROTECTIVE SECURITY SCREEN BUILD INTO FRAME EXTERNALLY. WALL PROFILE: CAPRAL 425 NARROWLINE COMMERCIAL FRAME 50 X 100 PROFILE WITH SILICONE SUB SILL. SIZE: AS PER WINDOW AND GLAZED DOOR SCHEDULE.  MATERIAL: ALUMINIUM FRAME IN SELECTED ANODISED FINISH. ACOUSTIC RATING: RW 41  ENERGY RATING: MAX U-VALUE 6.7; MAX SHGC VALUES 0.70.  SELECTION: WEATHERPROOF AIR VENTILATION LOUVRE WITH PERFORATED ALUMINIUM MESH. DESCRIPTION: ALUMINIUM FIXED LOUVRE WITH HORIZONTAL CURVED METAL WEATHERPROOF BLADES SET INTO CHANNEL SECTION FRAMES WITH INSECT MESH AND FIXED INTO OPENINGS. FREE AREA: TO MECHANICAL ENGINEER SPECIFICATION  SELECTION: WEATHERPROOF AIR VENTILATION LOUVRE DESCRIPTION: GLASS FIXED LOUVRE WITH HORIZONTAL CURVED METAL WEATHERPROOF BLADES SET INTO CHANNEL SECTION FRAMES WITH INSECT MESH AND FIXED INTO OPENINGS. FREE AREA: TO MECHANICAL ENGINEER SPECIFICATION  SELECTION: WEATHERPROOF AIR VENTILATION LOUVRE DESCRIPTION: GLASS FIXED LOUVRE WITH HORIZONTAL CURVED METAL WEATHERPROOF BLADES SET INTO CHANNEL SECTION FRAMES WITH INSECT MESH AND FIXED INTO OPENINGS FREE AREA: TO MECHANICAL ENGINEER SPECIFICATION  SELECTION: EXTERNAL COMMERCIAL FLUSH GLAZED FRAMING & AUTOMATIC SLIDING DOOR SYSTEM. DESCRIPTION: PROPRIETARY DOUBLE GLAZED ALUMINIUM ANODISED FIXED PANEL TO SUIT WIND LOAD AS PER	TBC	COMMERCIAL FRAME 50 X 100 PROFILE WITH SILICONE SUB SILL.  REFERENCE PRODUCT: CONSTRUCTION SPECIALIST PERFORM LOUVERS  TBC  CAPRAL 425 NARROWLINE COMMERCIAL FRAME 50 X 100	FINISH: MATTE GLAZING: 10.5mm HUSH + 12mm AIR + 6.3mm LAMINATED GLAZING  FINISH: P8 ANODISED FINISH: MATT  FINISH: MATT  PAINT: P8 ANODISED FINISH: MATT	AAF EVERSHIELD ANODISED - EBONY - Exx-T26M  COLOUR: DULUX FLUOROSET POWDER COATED - XTREME	Green  EBONY   EXXYZEM  EBONY   EXXYZEM  AND THE STATE OF
LVR-01  LVR-02  DOORS	WEATHERPROOF LOUVRE  WEATHERPROOF LOUVRE  COMMERCIAL FLUSH EXTERNAL GLAZED FRAMING & SLIDING DOOR	I DESCRIPTION: PROPRIETARY DOUBLE GLAZED ALUMINIUM ANODISED FIXED PANEL TO SUIT WIND LOAD AS PER STRUCTURAL HEGO ETAILS. SPECIFIED PROTECTIVE SECURITY SCREEN BUILD INTO FRAME EXTERNALLY. WALL PROFILE: CAPRAL 425 NARROWLINE COMMERCIAL FRAME 50 X 100 PROFILE WITH SILICONE SUB SILL. SIZE: AS PER WINDOW AND GLAZED DOOR SCHEDULE.  MATERIAL: ALUMINIUM FRAME IN SELECTED ANODISED FINISH.  ACOUSTIC RATING: RW 41  ENERGY RATING: MAX U-VALUE 6.7; MAX SHGC VALUES 0.70.  SELECTION: WEATHERPROOF AIR VENTILATION LOUVRE WITH PERFORATED ALUMINIUM MESH.  DESCRIPTION: ALUMINIUM FIXED LOUVRE WITH HORIZONTAL CURVED METAL WEATHERPROOF BLADES SET INTO CHANNEL SECTION FRAMES WITH INSECT MESH AND FIXED INTO OPENINGS.  FREE AREA: TO MECHANICAL ENGINEER SPECIFICATION  SELECTION: WEATHERPROOF AIR VENTILATION LOUVRE DESCRIPTION: GLASS FIXED LOUVRE WITH HORIZONTAL CURVED METAL WEATHERPROOF BLADES SET INTO CHANNEL SECTION FRAMES WITH INSECT MESH AND FIXED INTO OPENINGS.  FREE AREA: TO MECHANICAL ENGINEER SPECIFICATION  SELECTION: EXTERNAL COMMERCIAL FLUSH GLAZED FRAMING & AUTOMATIC SLIDING DOOR SYSTEM.  DESCRIPTION: PROPRIETARY DOUBLE GLAZED ALUMINIUM ANODISED FIXED PANEL TO SUIT WIND LOAD AS PER STRUCTURAL ENG DETAILS. SPECIFIED PROTECTIVE SECURITY SCREEN BUILD INTO FRAME EXTERNALLY WITH INTEGRATEH HINGED DOOR SYSTEM.	TBC	COMMERCIAL FRAME 50 X 100 PROFILE WITH SILICONE SUB SILL.  REFERENCE PRODUCT: CONSTRUCTION SPECIALIST PERFORM LOUVERS  TBC  CAPRAL 425 NARROWLINE	FINISH: MATTE GLAZING: 10.5mm HUSH + 12mm AIR + 6.3mm LAMINATED GLAZING  FINISH: P8 ANODISED FINISH: MATT  FINISH: MATT  PAINT: P8 ANODISED	AAF EVERSHIELD ANODISED - EBONY - Exx-T26M  COLOUR: DULUX FLUOROSET POWDER COATED - XTREME	Green  EBONY   EXXYZEM  EBONY   EXXYZEM  AND THE STATE OF
LVR-01  LVR-02  DOORS	WEATHERPROOF LOUVRE  WEATHERPROOF LOUVRE  COMMERCIAL FLUSH EXTERNAL GLAZED FRAMING & SLIDING DOOR	DESCRIPTION: PROPRIETARY DOUBLE GLAZED AUMINIUM ANDOISED FIXED PANEL TO SUIT WIND LOAD AS PER STRUCTURAL ENG DETAILS. SPECIFIED PROTECTIVE SECURITY SCREEN BUILD INTO FRAME EXTERNALLY. WALL PROFILE: CAPRAL 42S NARROWLINE COMMERCIAL FRAME 50 X 100 PROFILE WITH SILICONE SUB SILL. SIZE: AS PER WINDOW AND GLAZED DOOR SCHEDULE. MATERIAL: ALUMINIUM FRAME IN SELECTED ANDOISED FINISH. ACOUSTIC RATING: RW 41  ENERGY RATING: MAX U-VALUE 6.7; MAX SHGC VALUES 0.70.  SELECTION: WEATHERPROOF AIR VENTILATION LOUVRE WITH PERFORATED ALUMINIUM MESH. DESCRIPTION: ALUMINIUM FIXED LOUVRE WITH HORIZONTAL CURVED METAL WEATHERPROOF BLADES SET INTO CHANNEL SECTION FRAMES WITH INSECT MESH AND FIXED INTO OPENINGS. FREE AREA: TO MECHANICAL ENGINEER SPECIFICATION  SELECTION: WEATHERPROOF AIR VENTILATION LOUVRE DESCRIPTION: GLASS FIXED LOUVRE WITH HORIZONTAL CURVED METAL WEATHERPROOF BLADES SET INTO CHANNEL SECTION FRAMES WITH INSECT MESH AND FIXED INTO OPENINGS. FREE AREA: TO MECHANICAL ENGINEER SPECIFICATION  SELECTION: EXTERNAL COMMERCIAL FLUSH GLAZED FRAMING & AUTOMATIC SLIDING DOOR SYSTEM. SECURION: EXTERNAL COMMERCIAL FLUSH GLAZED FRAMING & AUTOMATIC SLIDING DOOR SYSTEM. SETUCTURAL ENG DETAILS. SPECIFIED PROTECTIVE SECURITY SCREED BUILD INTO FRAME EXTERNALLY WITH INTEGRATED HINGED DOOR SYSTEM.  SELECTION: EXTERNAL COMMERCIAL FLUSH GLAZED FRAMING & AUTOMATIC SLIDING DOOR SYSTEM.  SELECTION: EXTERNAL COMMERCIAL FLUSH GLAZED FRAMING & AUTOMATIC SLIDING DOOR SYSTEM.  SELECTION: EXTERNAL COMMERCIAL FLUSH GLAZED FRAMING & AUTOMATIC SLIDING DOOR SYSTEM.  SELECTION: EXTERNAL COMMERCIAL FLUSH GLAZED FRAMING & AUTOMATIC SLIDING DOOR SYSTEM.  SELECTION: EXTERNAL COMMERCIAL FLUSH GLAZED FRAMING & AUTOMATIC SLIDING DOOR SYSTEM.  SELECTION: EXTERNAL COMMERCIAL FLUSH GLAZED FRAMING & AUTOMATIC SLIDING DOOR SYSTEM.  SELECTION EXTERNAL COMMERCIAL FLUSH GLAZED FRAMING & AUTOMATIC SLIDING DOOR SYSTEM.  SELECTION EXTERNAL COMMERCIAL FLUSH GLAZED FRAMING & AUTOMATIC SLIDING DOOR SYSTEM.  SELECTION EXTERNAL COMMERCIAL FLUSH GLAZED FRAMING & AUTOMATIC SLIDIN	TBC	COMMERCIAL FRAME 50 X 100 PROFILE WITH SILICONE SUB SILL.  REFERENCE PRODUCT: CONSTRUCTION SPECIALIST PERFORM LOUVERS  TBC  CAPRAL 425 NARROWLINE COMMERCIAL FRAME 50 X 100 PROFILE WITH SILICONE SUB	FINISH: MATTE GLAZING: 10.5mm HUSH + 12mm AIR + 6.3mm LAMINATED GLAZING  FINISH: P8 ANODISED FINISH: MATT  PAINT: P8 ANODISED FINISH: MATT  PAINT: P8 ANODISED FINISH: MATT  PAINT: P8 ANODISED FINISH: MATTE GLAZING: 10.5mm HUSH + 12mm AIR + 6.3mm	AAF EVERSHIELD ANODISED - EBONY - Exx-T26M  COLOUR: DULUX FLUOROSET POWDER COATED - XTREME	Green  EBONY   EXXYZEM  EBONY   EXXYZEM  AND THE STATE OF
LVR-01  LVR-02  DOORS	WEATHERPROOF LOUVRE  WEATHERPROOF LOUVRE  COMMERCIAL FLUSH EXTERNAL GLAZED FRAMING & SLIDING DOOR	DESCRIPTION: PROPRIETARY DOUBLE GLAZED ALUMINIUM ANDDISED FIXED PANEL TO SUIT WIND LOAD AS PER STRUCTURAL LENG DETAILS. SPECIFIED PROTECTIVE SECURITY SCREEN BUILD INTO FRAME EXTERNALLY. WALL PROFILE: CAPRAL 42S NARROWAINE COMMERCIAL FRAME 50 X 100 PROFILE WITH SILICONE SUB SILL. SIZE: AS PER (MINDOW AND GLAZED DOOR SCHEDULE: MATERIA: ALUMINIUM FRAME IN SELECTED ANDDISED FINISH. ACOUSTIC RATING: RW 41 ENERGY RATING: RW 41 ENERGY RATING: MAX U-VALUE 6.7; MAX SHGC VALUES 0.70.  SELECTION: WEATHERPROOF AIR VENTILATION LOUVRE WITH PERFORATED ALUMINIUM MESH. DESCRIPTION: ALUMINIUM FIXED LOUVRE WITH HORIZONTAL CURVED METAL WEATHERPROOF BLADES SET INTO CHANNEL SECTION FRAMES WITH INSECT MESH AND FIXED INTO OPENINGS. FREE AREA: TO MECHANICAL ENGINEER SPECIFICATION  SELECTION: WEATHERPROOF AIR VENTILATION LOUVRE DESCRIPTION: GLASS FIXED LOUVRE WITH HORIZONTAL CURVED METAL WEATHERPROOF BLADES SET INTO CHANNEL DESCRIPTION: GLASS FIXED LOUVRE WITH HORIZONTAL CURVED METAL WEATHERPROOF BLADES SET INTO CHANNEL SECTION FRAMES WITH INSECT MESH AND FIXED AND FIXED SHAPE SET INTO CHANNEL SECTION FRAMES WITH INSECT MESH AND FIXED SHAPE S	TBC	COMMERCIAL FRAME 50 X 100 PROFILE WITH SILICONE SUB SILL.  REFERENCE PRODUCT: CONSTRUCTION SPECIALIST PERFORM LOUVERS  TBC  CAPRAL 425 NARROWLINE COMMERCIAL FRAME 50 X 100 PROFILE WITH SILICONE SUB	FINISH: MATTE GLAZING: 10.5mm HUSH + 12mm AIR + 6.3mm LAMINATED GLAZING  FINISH: P8 ANODISED FINISH: MATT  PAINT: P8 ANODISED FINISH: MATT  PAINT: P8 ANODISED FINISH: MATT  PAINT: P8 ANODISED FINISH: MATTE GLAZING: 10.5mm HUSH + 12mm AIR + 6.3mm	AAF EVERSHIELD ANODISED - EBONY - Exx-T26M  COLOUR: DULUX FLUOROSET POWDER COATED - XTREME	Green  EBONY   EXXYZEM  EBONY   EXXYZEM  AND THE STATE OF
LVR-01  LVR-02  DOORS	WEATHERPROOF LOUVRE  WEATHERPROOF LOUVRE  COMMERCIAL FLUSH EXTERNAL GLAZED FRAMING & SLIDING DOOR	DESCRIPTION: PROPRIETARY DOUBLE GLAZED AUMINIUM ANDDISED FIXED PANEL TO SUIT WIND LOAD AS PER STRUCTURAL LENG DETAILS. SPECIFIED PROTECTIVE SECURITY SCREEN BUILD INTO FRAME SETERNALLY. WALL PROFILE: CAPRAL 42S MARROWILINE COMMERCIAL FRAME 50 X 100 PROFILE WITH SILICONE SUB SILL. SIZE: AS PER WINDOW AND GLAZED DOOR SCHEDULE.  MATERIAL: ALUMINIUM FRAME IN SELECTED ANDDISED FINISH.  ACQUISTIC RATING: RW 41  ENERGY RATING: MAX U-VALUE 6.7; MAX SHGC VALUES 0.70.  SELECTION: WEATHERPROOF AIR VENTILATION LOUVRE WITH PERFORATED ALUMINIUM MESH.  DESCRIPTION: ALUMINIUM FIXED LOUVRE WITH HORIZONTAL CURVED METAL WEATHERPROOF BLADES SET INTO CHANNEL SECTION FRAMES WITH INSECT MESH AND FIXED INTO OPENINGS.  FREE AREA. TO MECHANICAL ENGINEER SPECIFICATION  SELECTION: WEATHERPROOF AIR VENTILATION LOUVRE  DESCRIPTION: GLASS FIXED LOUVRE WITH HORIZONTAL CURVED METAL WEATHERPROOF BLADES SET INTO CHANNEL SECTION FRAMES WITH INSECT MESH AND FIXED INTO OPENINGS.  FREE AREA. TO MECHANICAL ENGINEER SPECIFICATION  SELECTION: EXTERNAL COMMERCIAL FLUSH GLAZED FRAMING & AUTOMATIC SLIDING DOOR SYSTEM.  DESCRIPTION: PROPRIETARY DOUBLE GLAZED ALUMINIUM ANDDISED FIXED PANEL TO SUIT WIND LOAD AS PER STRUCTURAL ENG PETALS. SPECIFIED PROTECTIVE SECURITY SCREEN BUILD INTO FRAME EXTERNALLY WITH INTEGRATED HINGED DOOR SYSTEM.  WALL PROFILE: CAPRAL 22S LAZED MARROWILINE COMMERCIAL FRAME 50 X 100 PROFILE WITH SILICONE SUB SILL.  DOOR PROFILE: CAPRAL 22S HINGED DOOR OR SLIDING DOOR. ALLOW MIN 75MM HIGH DOOR HEAD TRANSOM SUB HEAD FOR THE FIXING OF AUTOMATIC DOOR CLOSER.	TBC	COMMERCIAL FRAME 50 X 100 PROFILE WITH SILICONE SUB SILL.  REFERENCE PRODUCT: CONSTRUCTION SPECIALIST PERFORM LOUVERS  TBC  CAPRAL 425 NARROWLINE COMMERCIAL FRAME 50 X 100 PROFILE WITH SILICONE SUB	FINISH: MATTE GLAZING: 10.5mm HUSH + 12mm AIR + 6.3mm LAMINATED GLAZING  FINISH: P8 ANODISED FINISH: MATT  PAINT: P8 ANODISED FINISH: MATT  PAINT: P8 ANODISED FINISH: MATT  PAINT: P8 ANODISED FINISH: MATTE GLAZING: 10.5mm HUSH + 12mm AIR + 6.3mm	AAF EVERSHIELD ANODISED - EBONY - Exx-T26M  COLOUR: DULUX FLUOROSET POWDER COATED - XTREME	Green  EBONY   EXXYZEM  EBONY   EXXYZEM  AND THE STATE OF
LVR-01  LVR-02  DOORS	WEATHERPROOF LOUVRE  WEATHERPROOF LOUVRE  COMMERCIAL FLUSH EXTERNAL GLAZED FRAMING & SLIDING DOOR	DESCRIPTION: PROPRIETARY DOUBLE CLAZED ALUMINIUM ANODISED FIXED PANEL TO SUIT WIND LOAD AS PER STRUCTURA END GETAILS, SECIFIED PROTECTIVE SECLIFITY SCREEN BUILD INTO FRAME EXTERNALLY. WALL PROFILE: CAPPAL 425 NARROWLINE COMMERCIAL FRAME 50 X 100 PROFILE WITH SILICONE SUB SILL. SZEZ: AS PER WINDOW AND CLAZED DOOR SCHEDULE. MATERIAL: ALUMINIUM FRAME IN SELECTED ANODISED FINISH. ACOUSTIC RATING: RW 41  ENERGY RATING: RW 41  ENERGY RATING: MAX U-VALUE 6.7; MAX SHGC VALUES 0.70.  SELECTION: WEATHERPROOF AIR VENTILATION LOUVRE WITH PERFORATED ALUMINIUM MESH. DESCRIPTION: ALUMINIUM FIXED LOUVRE WITH HORIZONTAL CURVED METAL WEATHERPROOF BLADES SET INTO CHANNEL SECTION FRAMES WITH INSECT MESH AND FIXED INTO OPENINGS. FREE AREA: TO MECHANICAL ENGINEER SPECIFICATION  SELECTION: WEATHERPROOF AIR VENTILATION LOUVRE DESCRIPTION: GLASS FIXED LOUVRE WITH HORIZONTAL CURVED METAL WEATHERPROOF BLADES SET INTO CHANNEL FREE AREA: TO MECHANICAL ENGINEER SPECIFICATION  SELECTION: FRAMES WITH INSECT MESH AND FIXED INTO OPENINGS FREE AREA: TO MECHANICAL ENGINEER SPECIFICATION  SELECTION: EXTERNAL COMMERCIAL FLUSH GLAZED FRAMING & AUTOMATIC SLIDING DOOR SYSTEM. DESCRIPTION: DEPORTETARY DOUBLE GLAZED ALUMINIUM ANODISED FIXED FRAME AND STRUCTURAL BEAG DETAILS. SPECIFIED PROTECTIVE SECURITY SCREEN BUILD INTO FRAME EXTERNALLY WITH INTEGRATEL HINGED DOOR SYSTEM.  WALL PROFILE: CAPPAL 425 NARROWLINE COMMERCIAL FRAME 50 X 100 PROFILE WITH SILICONE SUB SILL WALL PROFILE: CAPPAL 425 RINGED DOOR OR SLIDING DOOR ALLOW MIN 75MM HIGH DOOR HEAD TRANSOM SUB HEAD FOR THE FIXING GF AUTOMATIC DOOR CLOSER.  WATER FRAME: ALUMINIUM FRAME IN SELECTED ANDDISED FINISH. ACCOUSTIC RATING: RW 41	TBC	COMMERCIAL FRAME 50 X 100 PROFILE WITH SILICONE SUB SILL.  REFERENCE PRODUCT: CONSTRUCTION SPECIALIST PERFORM LOUVERS  TBC  CAPRAL 425 NARROWLINE COMMERCIAL FRAME 50 X 100 PROFILE WITH SILICONE SUB	FINISH: MATTE GLAZING: 10.5mm HUSH + 12mm AIR + 6.3mm LAMINATED GLAZING  FINISH: P8 ANODISED FINISH: MATT  PAINT: P8 ANODISED FINISH: MATT  PAINT: P8 ANODISED FINISH: MATT  PAINT: P8 ANODISED FINISH: MATTE GLAZING: 10.5mm HUSH + 12mm AIR + 6.3mm	AAF EVERSHIELD ANODISED - EBONY - Exx-T26M  COLOUR: DULUX FLUOROSET POWDER COATED - XTREME	Green  EBONY   EXXYZEM  EBONY   EXXYZEM  AND THE STATE OF
LVR-01  LVR-02  DOORS	WEATHERPROOF LOUVRE  WEATHERPROOF LOUVRE  COMMERCIAL FLUSH EXTERNAL GLAZED FRAMING & SLIDING DOOR	DESCRIPTION: PROPRIETARY DOUBLE CLAZED ALUMINIUM ANODISED FIXED PANEL TO SUIT WIND LOAD AS PER STRUCTURA END GETAILS, SECIFIED PROTECTIVE SECLIFITY SCREEN BUILD INTO FRAME EXTERNALLY. WALL PROFILE: CAPPAL 425 NARROWLINE COMMERCIAL FRAME 50 X 100 PROFILE WITH SILICONE SUB SILL. SZEZ: AS PER WINDOW AND CLAZED DOOR SCHEDULE. MATERIAL: ALUMINIUM FRAME IN SELECTED ANODISED FINISH. ACOUSTIC RATING: RW 41  ENERGY RATING: RW 41  ENERGY RATING: MAX U-VALUE 6.7; MAX SHGC VALUES 0.70.  SELECTION: WEATHERPROOF AIR VENTILATION LOUVRE WITH PERFORATED ALUMINIUM MESH. DESCRIPTION: ALUMINIUM FIXED LOUVRE WITH HORIZONTAL CURVED METAL WEATHERPROOF BLADES SET INTO CHANNEL SECTION FRAMES WITH INSECT MESH AND FIXED INTO OPENINGS. FREE AREA: TO MECHANICAL ENGINEER SPECIFICATION  SELECTION: WEATHERPROOF AIR VENTILATION LOUVRE DESCRIPTION: GLASS FIXED LOUVRE WITH HORIZONTAL CURVED METAL WEATHERPROOF BLADES SET INTO CHANNEL FREE AREA: TO MECHANICAL ENGINEER SPECIFICATION  SELECTION: FRAMES WITH INSECT MESH AND FIXED INTO OPENINGS FREE AREA: TO MECHANICAL ENGINEER SPECIFICATION  SELECTION: EXTERNAL COMMERCIAL FLUSH GLAZED FRAMING & AUTOMATIC SLIDING DOOR SYSTEM. DESCRIPTION: DEPORTETARY DOUBLE GLAZED ALUMINIUM ANODISED FIXED FRAME AND STRUCTURAL BEAG DETAILS. SPECIFIED PROTECTIVE SECURITY SCREEN BUILD INTO FRAME EXTERNALLY WITH INTEGRATEL HINGED DOOR SYSTEM.  WALL PROFILE: CAPPAL 425 NARROWLINE COMMERCIAL FRAME 50 X 100 PROFILE WITH SILICONE SUB SILL WALL PROFILE: CAPPAL 425 RINGED DOOR OR SLIDING DOOR ALLOW MIN 75MM HIGH DOOR HEAD TRANSOM SUB HEAD FOR THE FIXING GF AUTOMATIC DOOR CLOSER.  WATER FRAME: ALUMINIUM FRAME IN SELECTED ANDDISED FINISH. ACCOUSTIC RATING: RW 41	TBC	COMMERCIAL FRAME 50 X 100 PROFILE WITH SILICONE SUB SILL.  REFERENCE PRODUCT: CONSTRUCTION SPECIALIST PERFORM LOUVERS  TBC  CAPRAL 425 NARROWLINE COMMERCIAL FRAME 50 X 100 PROFILE WITH SILICONE SUB	FINISH: MATTE GLAZING: 10.5mm HUSH + 12mm AIR + 6.3mm LAMINATED GLAZING  FINISH: P8 ANODISED FINISH: MATT  PAINT: P8 ANODISED FINISH: MATT  PAINT: P8 ANODISED FINISH: MATT  PAINT: P8 ANODISED FINISH: MATTE GLAZING: 10.5mm HUSH + 12mm AIR + 6.3mm	AAF EVERSHIELD ANODISED - EBONY - Exx-T26M  COLOUR: DULUX FLUOROSET POWDER COATED - XTREME	Green  EBONY   EXXYZEM  EBONY   EXXYZEM  AND THE STATE OF

CLIENT:



ARCHITECT:



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PROJECT:

## 21030 BOMADERRY BASKETBALL STADIUM

REFURBISHMENT
84 CAMBEWARRA RD, BOMADERRY,
NSW 2541

DRAWING TITLE:

SCHEDULE - FINISHES - SHEET 1

SHEET NUMBER:

**DA6001** 

FINISHES SCHEDUI	ELEMENT	DESCIPTION	SUPPLIER	MODEL/PRODUCT	FINISH	COLOUR/CODE	IMAGE
NTERNAL FINISHES						00000.4002	
LOORS							
-	EX AMENITIES AND STORAGE AREA	REMOVE EX FLOORBOARD, FLOOR FINISHES. REPAIR PAD FOOTINGS WITH CARE, PACKING BETWEEN FLOOR FRAMING AND -BRICK PIERS MAY CONTAIN ASBESTOS AND CONTAMINATED MATERIALS. REPAIR AND REMEDIATE EX FLOOR BEARERS, JOISTS AND FOOTINGS TO STRUCTURAL ENGINEER DETAILS. ADD NEW FLOOR JOINTS TO STRUCTURAL ENGINEER DETAILS. ALLOWANCE FOR NEW FLOORING SYSTEM.		-	-	-	
	EX GAME COURT FLOORINGS	RETAIN AND PRESERVE EXISTING GAME COURT FLOORINGS FOR REINSTATEMENT WITH CARE, PACKING BETWEEN FLOOR FRAMING AND BRICK PIERS MAY CONTAIN ASBESTOS AND CONTAMINATED MATERIALS. FLOOR BOARDS TO BE REMOVED, STORED AND REINSTATED DURING REMEDIATION WORK TO FOOTINGS ARE REQUIRED.		-	-	-	
	PORTABLE RETRACTABLE TIERED SEATING (COURT 5)	SELECTION: PORTABLE TIERED SEATING CAN BE DIVIDED INTO SMALLER SECTIONS FOR MANUAL OPERATION.  SEAT SELECTION: TYPE 11 RISED TIMBER BENCH SEAT WITH HOT DIPPED GALVANISED STEEL FRAME.  MANUAL OPERATION: A FOOT CONTROLLED MECHANISM ALLOWS SEATS TO FOLD INTO THE STORED POSITION.  HANDRAILS REMOVABLE - PANEL TYPE DESIGN TO SUIT SOCKETS IN THE PLATFORM. SIDE HANDRAILS MYST BE REMOVED TO RETRACT UNIT.	CROMAT	ACROMAT RETRACTABLE TIER SEATING S10 PLATFORM	ED TBC	TBC	
-	FIXED RETRACTABLE TIERED SEATING (COUR' 6)	SELECTION: FIXED RETRACTABLE TIERED SEATING CAN BE DIVIDED INTO SMALLER SECTIONS FOR MOTORISED OPERATION AT TO BE EXTENDED AND RETRACTED.  SEAT SELECTION: TYPE 11 RISED TIMBER BENCH SEAT WITH HOT DIPPED GALVANISED STEEL FRAME.  AUTOMATIC OPERATION: UNIT EXTENDED AND RETRACTED ARE FULL MOTORISED.  HANDRAILS REMOVABLE - PANEL TYPE DESIGN TO SUIT SOCKETS IN THE PLATFORM. SIDE HANDRAILS MYST BE REMOVED TO RETRACT UNIT	CROMAT	ACROMAT RETRACTABLE TIER SEATING S10 PLATFORM	ED TBC	TBC	
WALLS							
-	INTERNAL COURT ACOUSTIC WALL LINING	SELECTION: BIRCH PLYWOOD PERFORATED WALL ACOOUSTIC CLADDING ON SUBSTRUCTURE SYSTEM WITH STANDARD ACOUSTIC BACKING FABRIC. PANEL SIZE: 1200W x 9MM THICK X 4200mm HIGH (COURT 6) PANEL SIZE: 1200W x 9MM THICK X 3600mm HIGH (COURT 5) FIRE PERFORMANCE: GROUP 1 EDGE: SQUARE		-	FINISH: NATURAL STAIN PERFORATION: TBC	-	
FITTINGS							
-	INTERNAL VERTICAL STORAGE SYSTEM	SELECTION: GALVANISED STEEL HEAVY DUTY METAL FRAME STORAGE SYSTEM WITH BIRCH PLYWOOD PERFORATED STORAGE CLADDING. STORAGE SIZE: VARIES WIDTH BETWEEN EXISING GRID STRUCTURE x 1200mm DEEP X 3500mm HIGH FIRE PERFORMANCE: GROUP 1		-	FINISH: NATURAL STAIN PERFORATION: TBC	-	
BIC	BICYCLE RACK		STREET FURNITURE JUSTRALIA	LINEA BICYCLE STAND OR APPROVED EQUIVALENT	FINISH: STAINLESS 304 METALL BRUSHED	JC BST07	

CLIENT:



ARCHITECT:



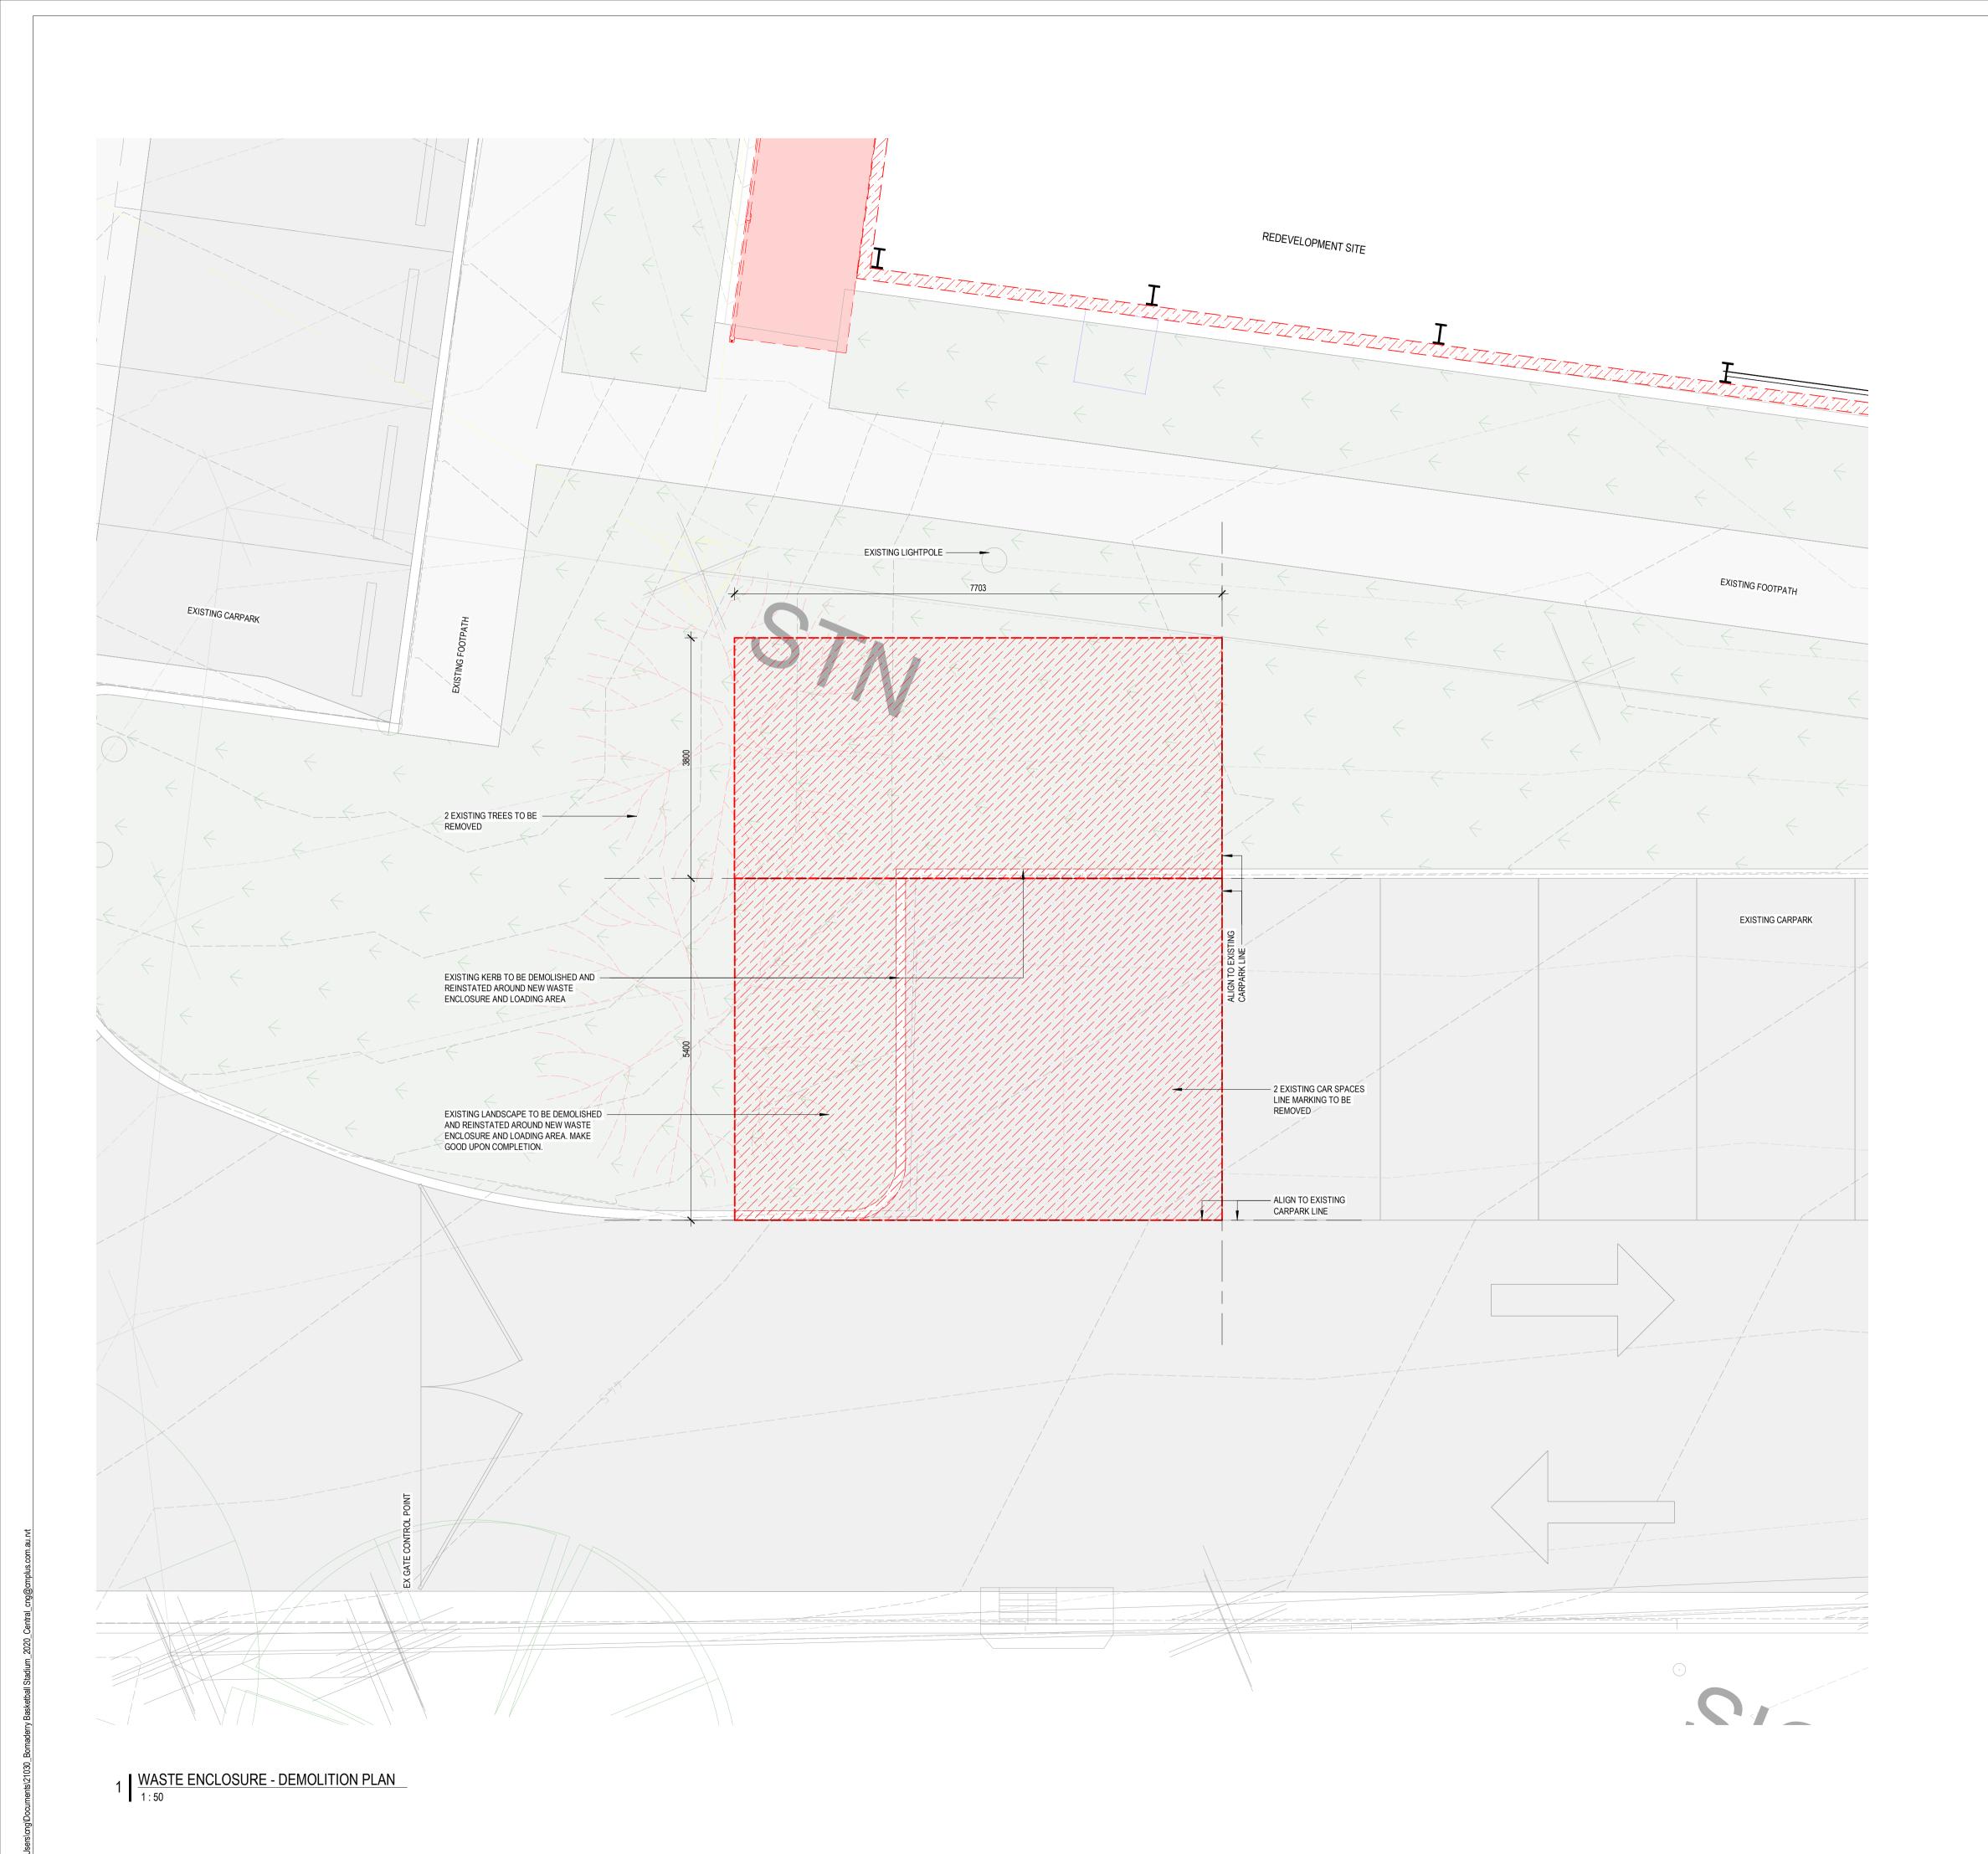
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PROJECT:

21030 BOMADERRY BASKETBALL STADIUM REFURBISHMENT 84 CAMBEWARRA RD, BOMADERRY, NSW 2541

DRAWING TITLE: SCHEDULE - FINISHES - SHEET 2

SHEET NUMBER: **DA6002** 



REV DATE DESCRIPTION
A 24.06.2022 ISSUE FOR DA DESIGN COORDINATION
B 28.06.2022 ISSUE FOR DA SUBMISSION C 12.09.2022 ISSUE FOR DA RFI SUBMISSION

WALL LEGEND BRICKWORK

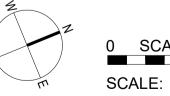
CONCRETE WORK EXISTING ELEMENT DEMOLISHED ELEMENT

BLOCKWORK NEW ELEMENT TEMPORARY ELEMENT

CLIENT:

ARCHITECT:

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SCALE: 1:50 @ A1

REV:

PROJECT:

21030

BOMADERRY BASKETBALL STADIUM REFURBISHMENT 84 CAMBEWARRA RD, BOMADERRY, NSW 2541

DRAWING TITLE: WASTE ENCLOSURE - DEMOLITION PLAN

SHEET NUMBER: **DA7001** 

PLOTTED: 29/06/2022 9:57:04 AM

together with all Authorities' requirements and Regulations. REV DATE DESCRIPTION
A 24.06.2022 ISSUE FOR DA DESIGN COORDINATION
B 28.06.2022 ISSUE FOR DA SUBMISSION C 20.07.2022 ISSUE FOR DETAIL DESIGN COORDINATION D 25.07.2022 ISSUE FOR DESIGN COORDINATION
E 05.08.2022 ISSUE FOR DA DESIGN COORDINATION F 24.08.2022 ISSUE FOR 95% DESIGN COORDINATION G 16.09.2022 NEW COLUMNS FLOOR PLAN LAYOUT
H 21.10.2022 ISSUE FOR 95% DESIGN COORDINATION
I 15.11.2022 ISSUE FOR BCA+ ACCESS REVIEW J 19.12.2022 ISSUE FOR 95% REVIEW
K 12.01.2023 ISSUE FOR (PAN-258788) RFI

WALL LEGEND

CONCRETE WORK EXISTING ELEMENT BRICKWORK DEMOLISHED ELEMENT

BLOCKWORK NEW ELEMENT

TEMPORARY ELEMENT

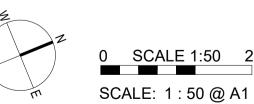
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PROJECT: 21030

BOMADERRY BASKETBALL STADIUM REFURBISHMENT 84 CAMBEWARRA RD, BOMADERRY,

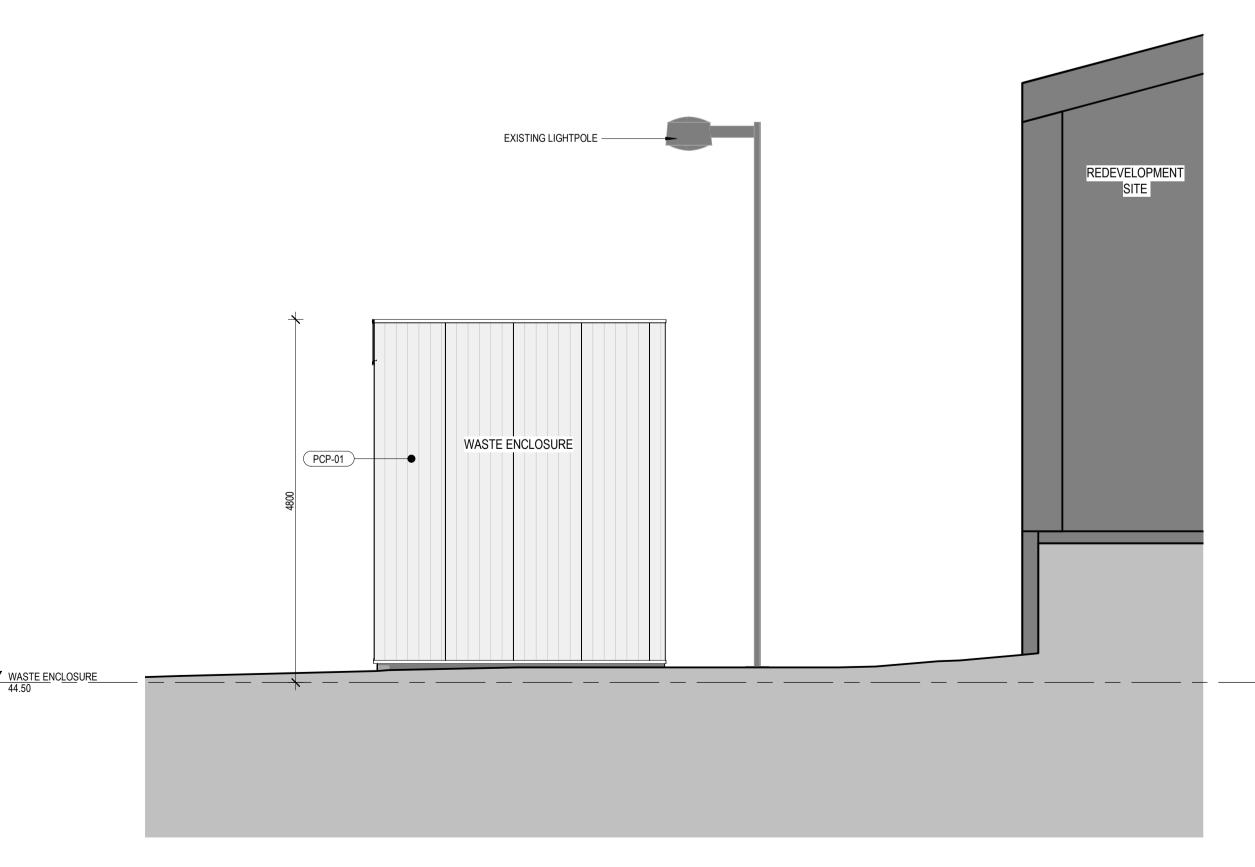
NSW 2541

DRAWING TITLE: PROPOSED WASTE ENCLOSURE -SITE PLAN

SHEET NUMBER: DA7101

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REDEVELOPMENT SITE (BEYOND) EXISTING LIGHTPOLE — (BEYOND) PCP-01 WASTE ENCLOSURE PCP-01 PCP-01 1 EAST ELEVATION
1:50



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Document Notes

Verify all dimensions on site before commencing work. Report all discrepancies to the Architect Prior to construction. Use figured dimensions in preference to scaled dimensions. Drawings made to larger scales and those showing particular parts of the works take precedence over drawings made to smaller scales or for general purposes. All work is to conform to relevant Australian Standards and Codes together with all Authorities' requirements and Regulations. REV DATE DESCRIPTION
A 24.06.2022 ISSUE FOR DA DESIGN COORDINATION
B 28.06.2022 ISSUE FOR DA SUBMISSION

C 12.09.2022 ISSUE FOR DA RFI SUBMISSION

WALL LEGEND

CONCRETE WORK EXISTING ELEMENT DEMOLISHED ELEMENT BRICKWORK

TEMPORARY ELEMENT

BLOCKWORK NEW ELEMENT

FINISHES SCHEDULE

MDR-01 PROFILED METAL ROOFING (WOODLAND GREY) PCR-01 POLYCARBONATE ROOFING (TRANSLUSCENT)

SS-01 STAINLESS STEEL PLATE

CMP-01 PROFILED METAL WALLING (WOODLAND GREY) PCP-01 POLYCARBONATE WALLING (TRANSLUSCENT)

CFC-01 COMPRESSED FIBRE CEMENT CLADDING

CFC-02 COMPRESSED FIBRE CEMENT CLADDING REPAIR PAINT APPLICATION TO EXISTING

EXTERNAL BRICKWORK PLY-01 BIRCH PLYWOOD PERFORATED WALL ACOUSTIC CLADDING

GWP-01 GLAZED WALL PARTITION

BAL-01 GALVANISED STEEL BALUSTRADE (BLACK) LVR-01 WEATHERPROOF LOUVRE

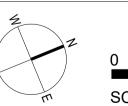
LVR-02 WEATHERPROOF LOUVRE

BIK BICYCLE RACK

CLIENT:

ARCHITECT:

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REV:

SCALE: As indicated @

PROJECT:

21030

BOMADERRY BASKETBALL STADIUM **REFURBISHMENT** 84 CAMBEWARRA RD, BOMADERRY,

NSW 2541 DRAWING TITLE:

WASTE ENCLOSURE - ELEVATIONS

SHEET NUMBER: **DA7201** 

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REDEVELOPMENT SITE (BEYOND) EXISTING LIGHTPOLE — (BEYOND) EXISTING LIGHTPOLE -REDEVELOPMENT SITE MDR-01 PCP-01 PCP-01 PCP-01 PCP-01 PCP-01 WASTE ENCLOSURE WASTE ENCLOSURE PCP-01

Document Notes

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A 24.06.2022 ISSUE FOR DA DESIGN COORDINATION
B 28.06.2022 ISSUE FOR DA SUBMISSION C 12.09.2022 ISSUE FOR DA RFI SUBMISSION

WALL LEGEND CONCRETE WORK EXISTING ELEMENT DEMOLISHED ELEMENT BRICKWORK BLOCKWORK NEW ELEMENT TEMPORARY ELEMENT

FINISHES SCHEDULE

MDR-01 PROFILED METAL ROOFING (WOODLAND GREY) PCR-01 POLYCARBONATE ROOFING (TRANSLUSCENT)

SS-01 STAINLESS STEEL PLATE

CMP-01 PROFILED METAL WALLING (WOODLAND GREY)

PCP-01 POLYCARBONATE WALLING (TRANSLUSCENT)

CFC-01 COMPRESSED FIBRE CEMENT CLADDING CFC-02 COMPRESSED FIBRE CEMENT CLADDING

REPAIR PAINT APPLICATION TO EXISTING EXTERNAL BRICKWORK

PLY-01 BIRCH PLYWOOD PERFORATED WALL ACOUSTIC CLADDING GWP-01 GLAZED WALL PARTITION

BAL-01 GALVANISED STEEL BALUSTRADE (BLACK)

LVR-01 WEATHERPROOF LOUVRE

LVR-02 WEATHERPROOF LOUVRE

BIK BICYCLE RACK

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0 SCALE 1:50 2 SCALE: As indicated @

REV:

PROJECT:

21030

BOMADERRY BASKETBALL STADIUM REFURBISHMENT 84 CAMBEWARRA RD, BOMADERRY, NSW 2541

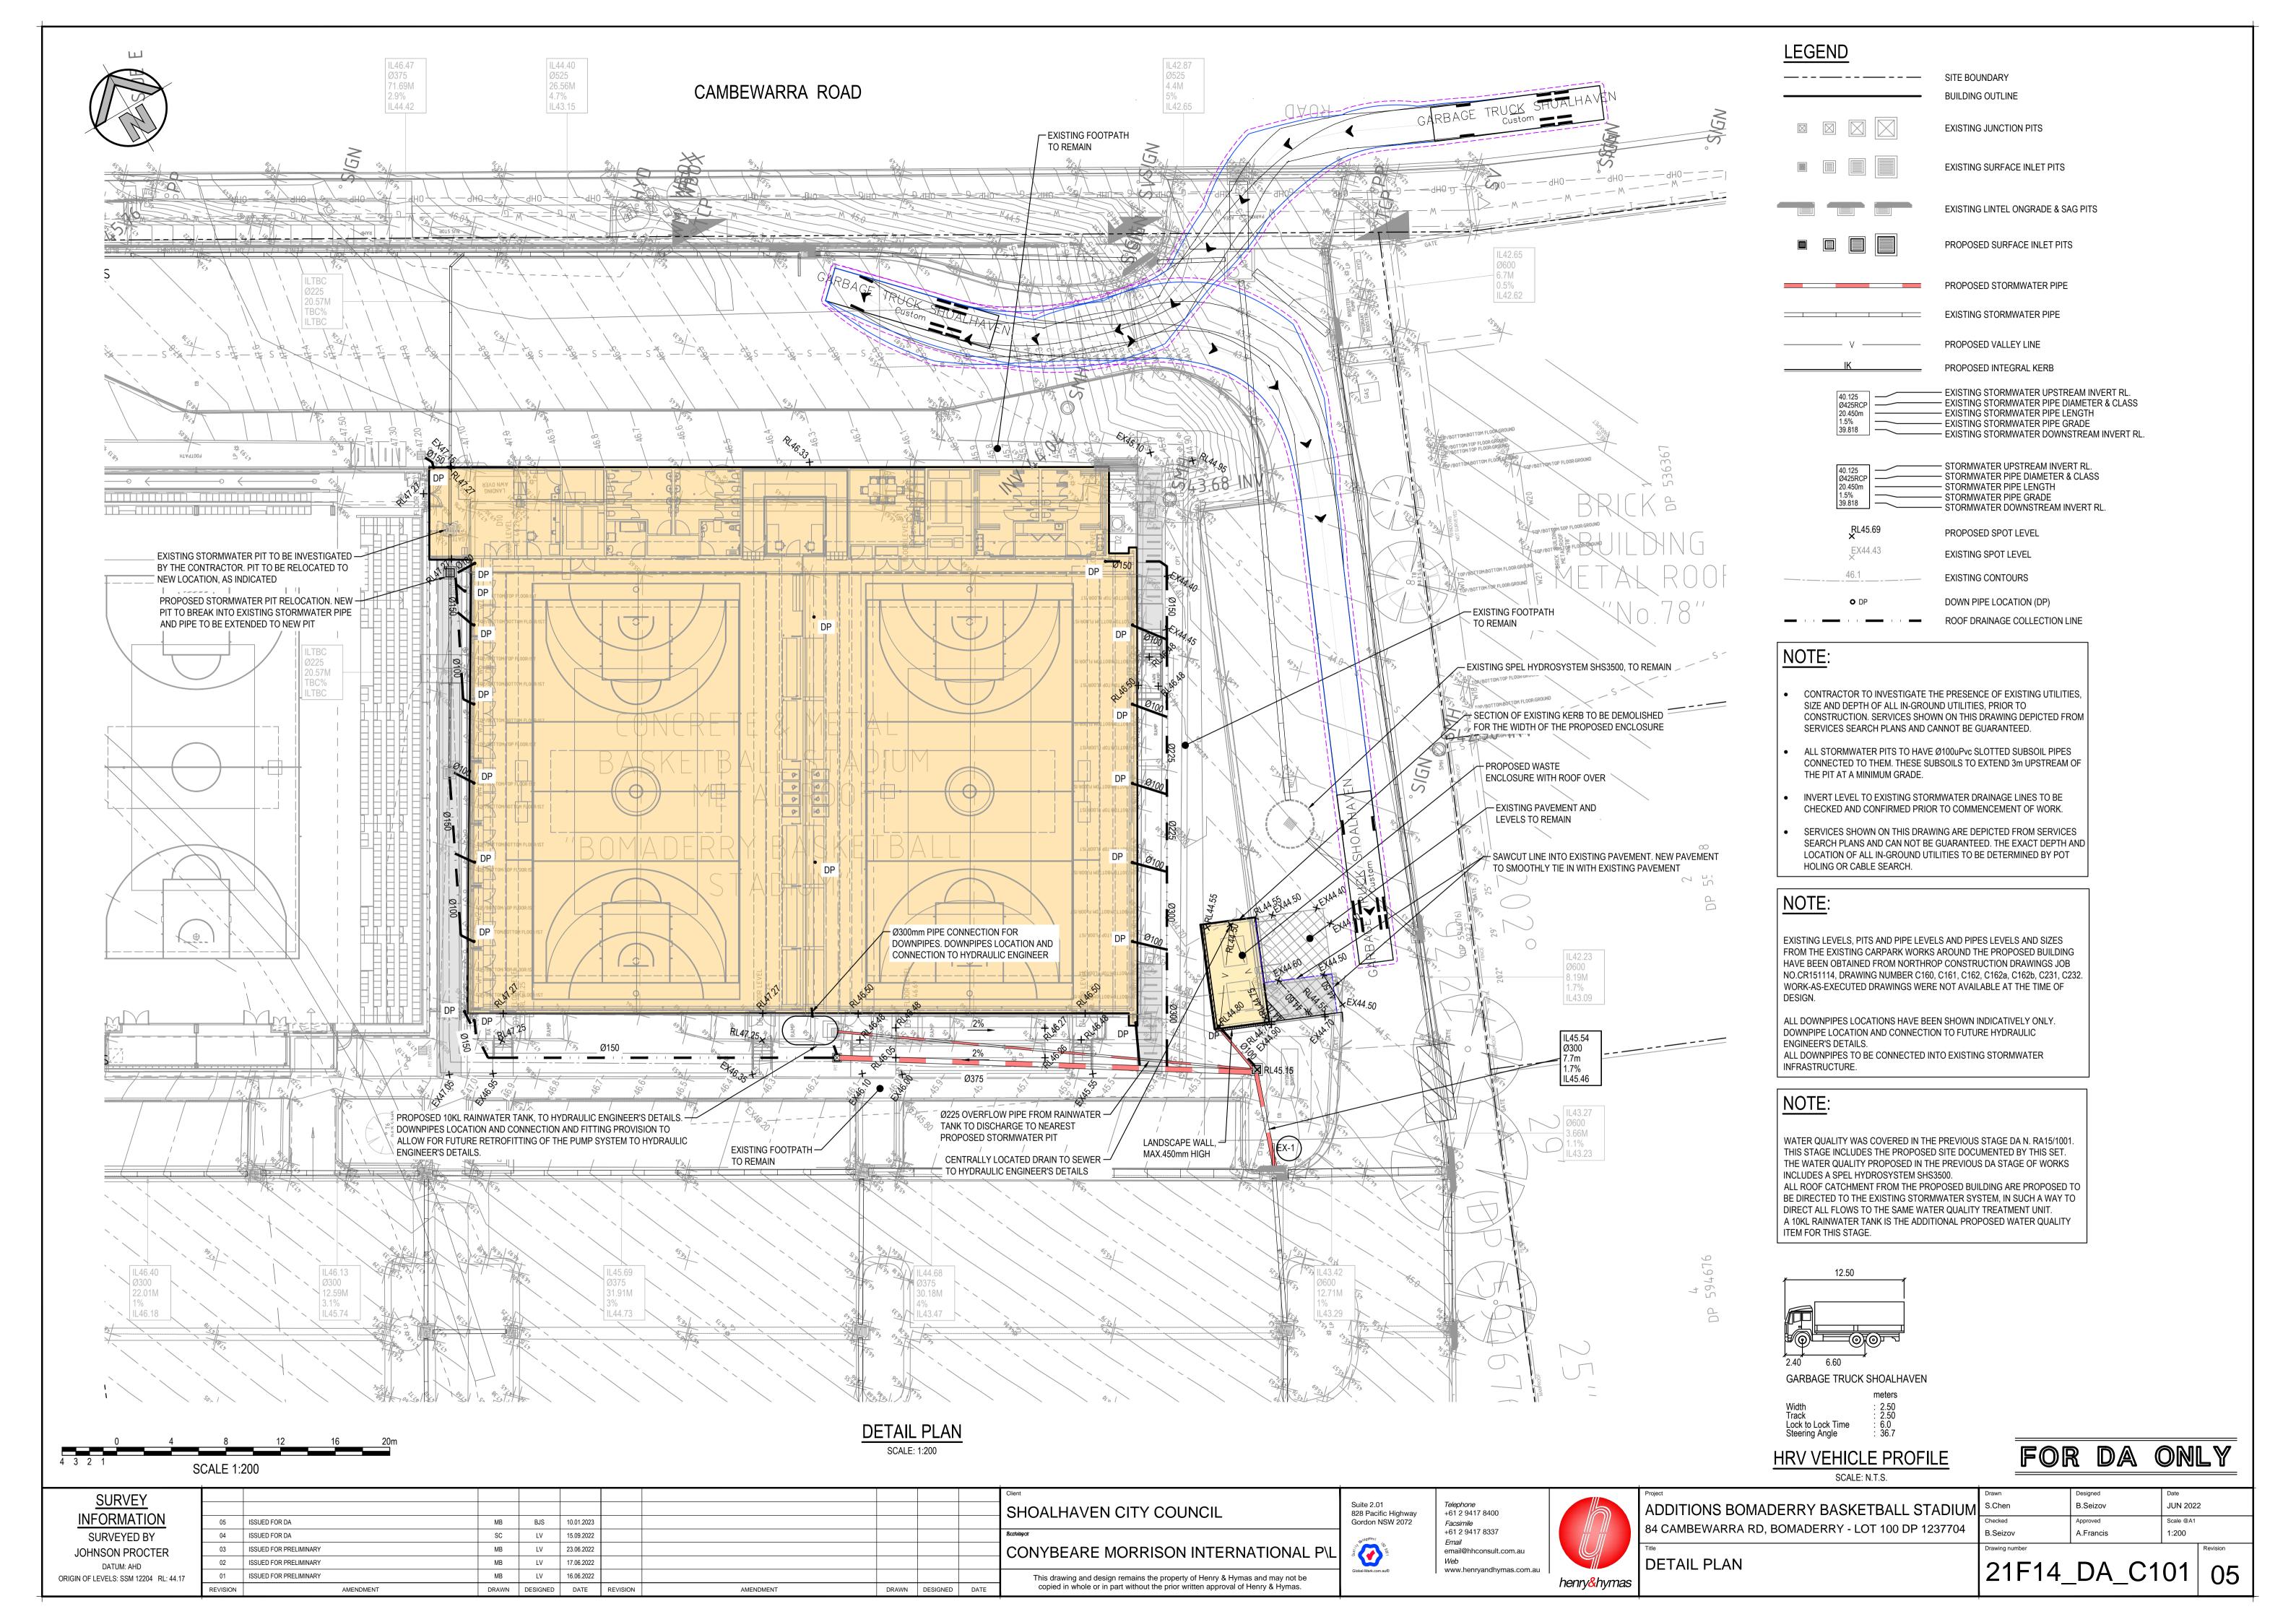
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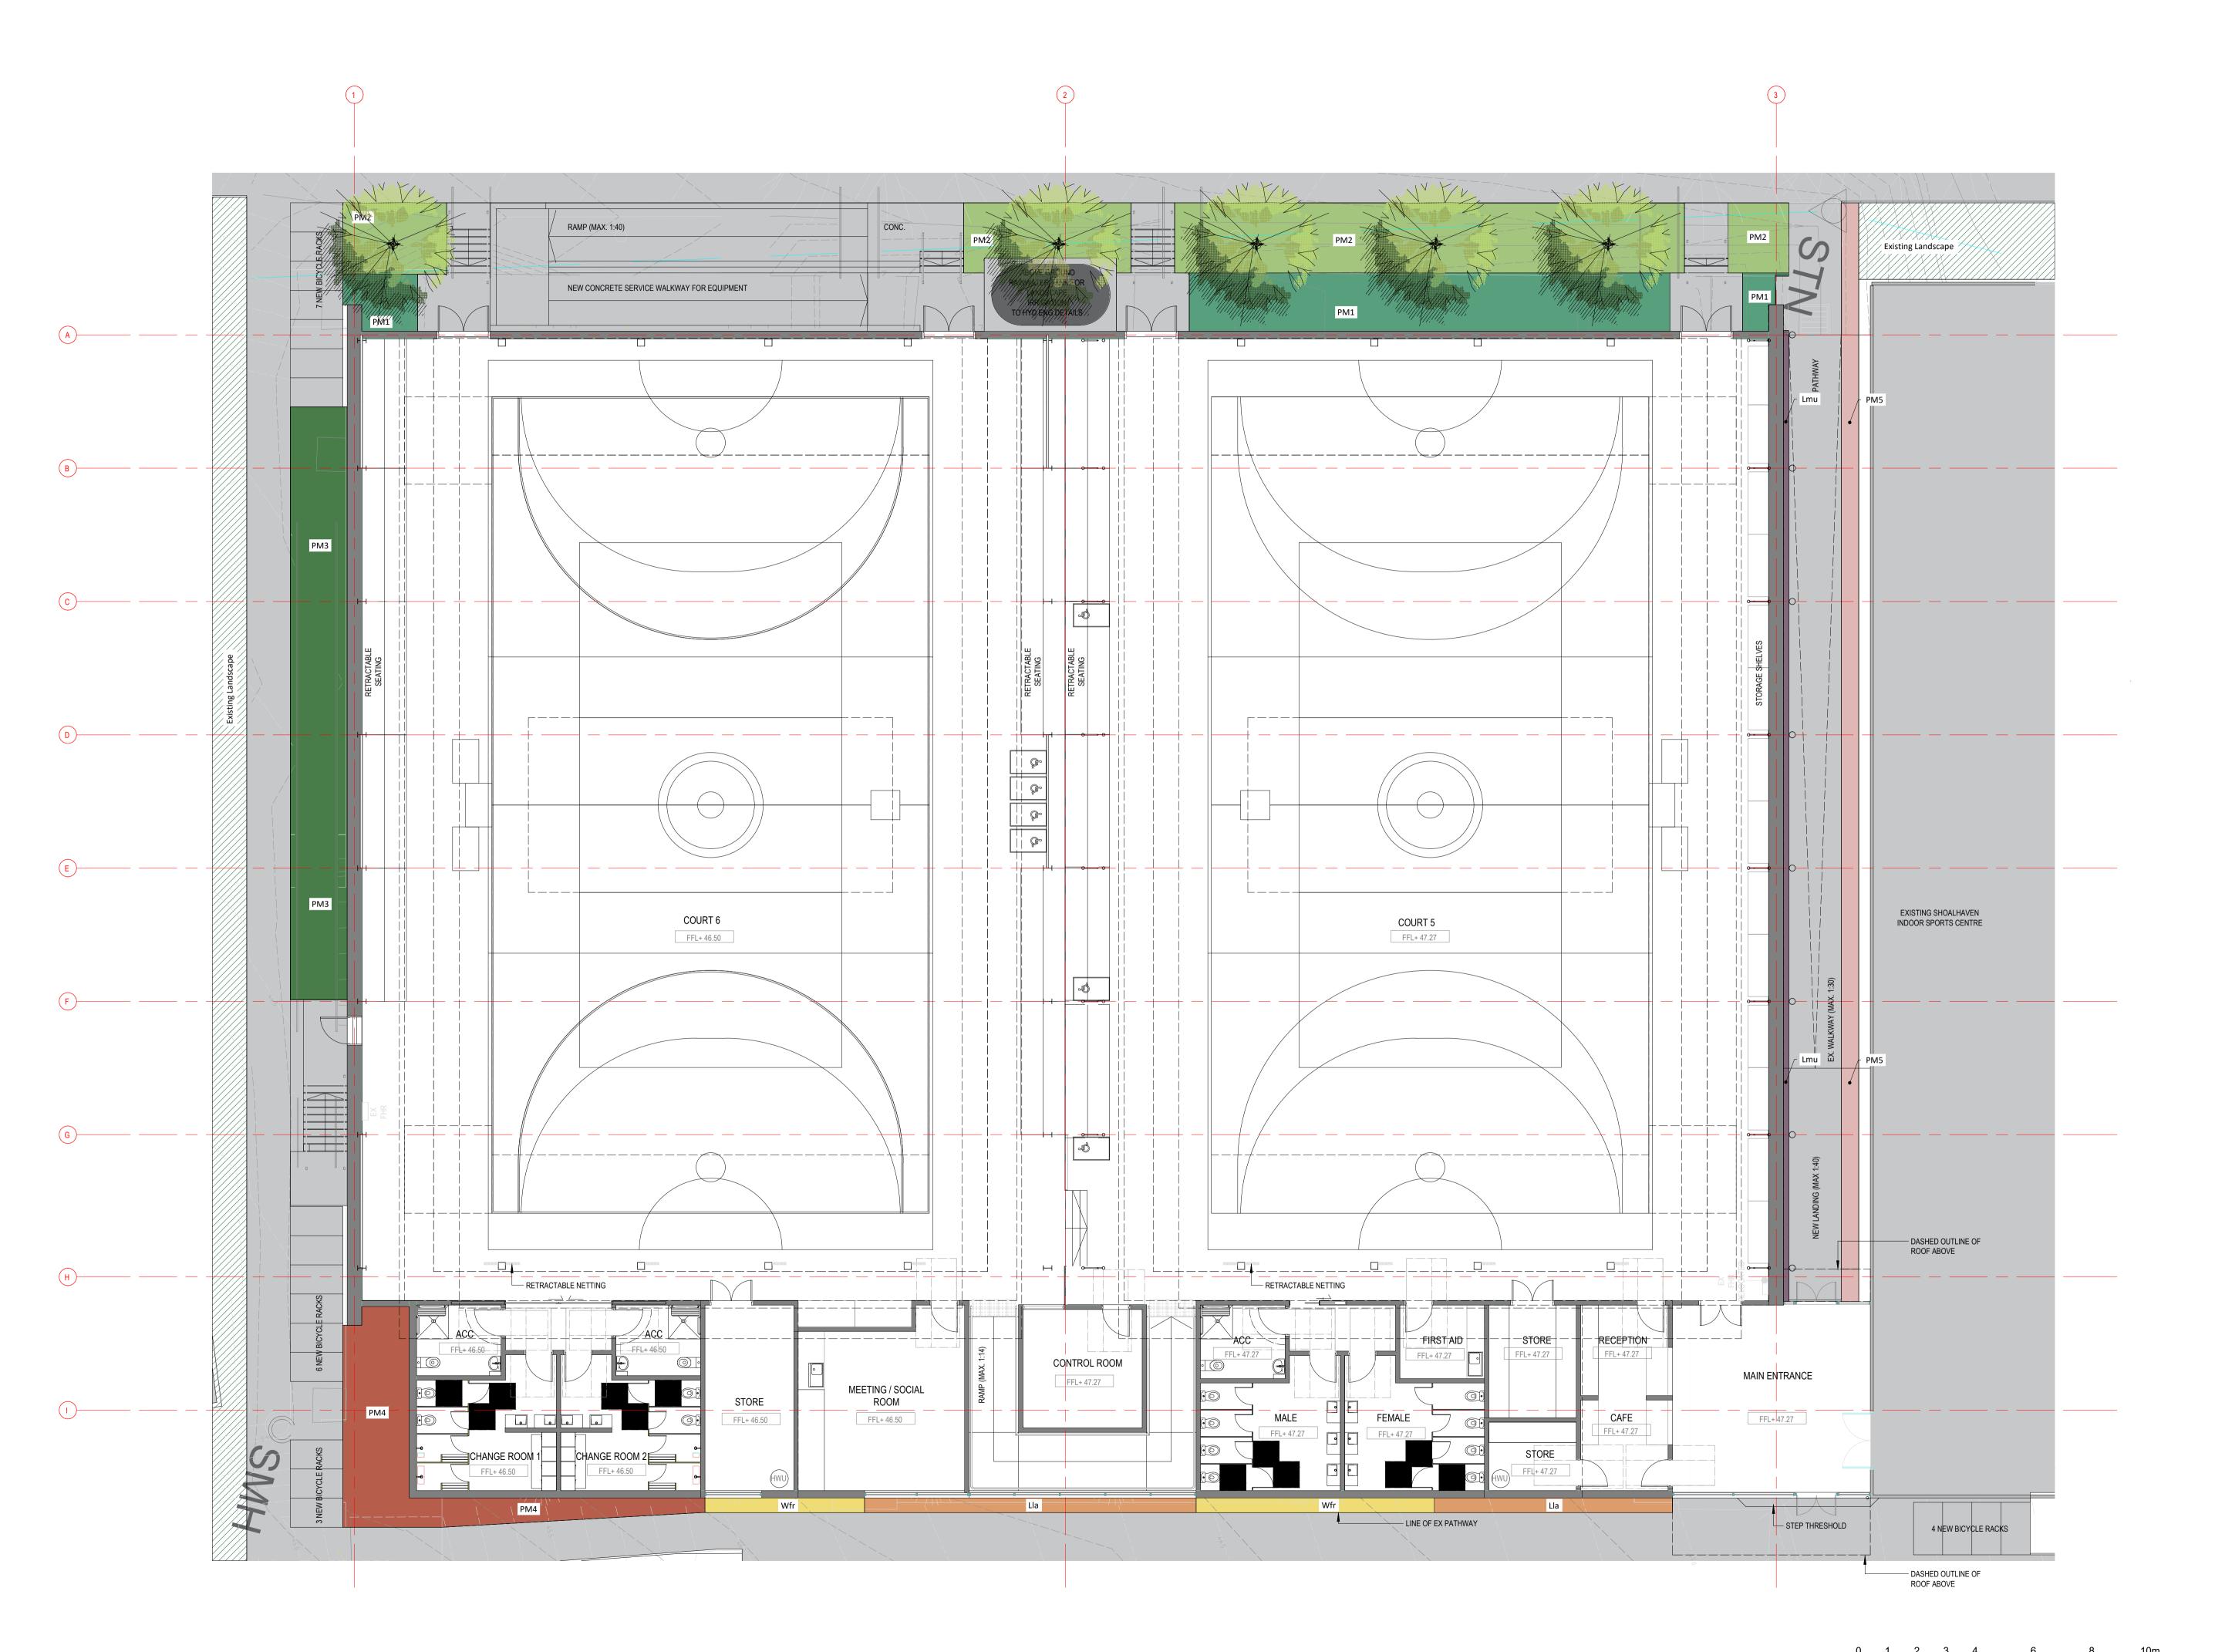
WASTE ENCLOSURE - SECTIONS

SHEET NUMBER: **DA7211** 

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**Shrubs and Groundcovers** Existing Landscape

Westringia fruticosa
Coastal rosemary Coastal rosemary
4kg @ 4/m²

Leptospermum laevigatum
Australian Myrtle
4kg @ 4/m²

Liriope muscari
Lily turf
4kg @ 4/m²

Planting Mix 1

Westringia fruticosa Coastal rosemary 4kg @ 2/m²

Kunzea ambigua White kunzea 4kg @ 1/m²

#### Planting Mix 2

Dianella caerulea
Blue Flax Lily
4kg @ 1/m²

Bauera rubioides River rose 4kg @ 1/m²

Crowea exalata Small Crowea 4kg @ 2/m²

### Planting Mix 3

Calytrix tetragona
Fringe myrtle
4kg @ 2/m²

Leptospermum laevigatum Australian myrtle 4kg @ 2/m²

# Planting Mix 4

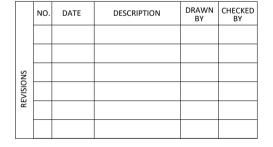
Grevillea 'Bronze rambler'
Grevillea
4kg @ 3/m²

Banksia spinulosa 'Bush candles' Banksia 10kg @ 1/m²

#### Planting Mix 5

Ajuga australis
Austral bugle
4kg @ 2/m²

Dianella tasmanica 'Splice' Native flax 4kg @ 3/m²





BOMADERRY BASKETBALL STADIUM 84 Cambewarra Rd, Bomaderry Lot 100 DP 1237704

DESCRIPTION: Landscape Sketch Plan

DWG #:	SQ1-BBS-100	Rev: D
DATE:	2022-09-14	
SCALE:	1:100 @ A1	

CHECKED BY: WV DOCUMENT CONTROL STATUS:

**FOR INFORMATION** 



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